TOWN OF WATERBURY ZONING PERMIT APPLICATION

Please provide all of the information requested in this application.

Read the Zoning Regulations and familiarize yourself with the requirements. Failure to provide all the required information will delay the process of this application. Based upon the nature of the project you may need to submit additional information. For instructions on how to fill out this form please refer to the Zoning Permit Application Instructions & Fee Schedule available on the municipal website or at the municipal offices. Submit one copy of the completed application and a check payable to the Town of Waterbury according to the zoning fee schedule. For questions about the permit process, please contact the Zoning Administrator at 802-244-1018.

CONTACT INFORMATION

APPLICANT	PROPER	TY OWNER (if different from Applicant)
Name:Justin & Nusi Brown	Name:	
Mailing Address:60 Winooski Falls	Way #1110 Mailing A	Address:
Winooski, VT 054	04	
Home Phone :	Home Ph	one :
Work/Cell Phone: <u>802-345-0397</u>	Work/Cel	ll Phone:
Email: justinbro@gmail.com	Email:	
PROJECT DESCRIPTION		CHECK ALL THAT APPLY:
Physical location of project (E911 address	s): <u>561 Bear Creek Ln</u>	NEW CONSTRUCTION
Lot size: 10.2 acres Zoning Distric	Conservation & RHS (minor) Two-Family Dwelling Multi-Family Dwelling
Existing Use: Undeveloped Prop		
Brief description of project:		Residential Building Addition
Construction of a single-family res		structure Comm./ Industrial Building Additi
		□ Accessory structure (garage, shed)
		Accessory Apartment Deals / Deals / Deals / Beau
	Spring 2022	□ Porch / Deck / Fence / Pool / Ram □ Development in SFHA (including
Cost of project: \$ Es		repairs and renovation)
Water system: <u>On-site well</u> W		
EXISITING	PROPOSED	USE -: <35' □ Establish new use
Square footage: <u>n/a</u> Height:	Square footage: <u>4596</u> Height	
Number of bedrooms/baths:		- Expand existing use
# of parking spaces:	# of parking spaces: 2	Establish home occupation
Setbacks: front:	Setbacks: front: 498'	OTHER
sides: /rear:	sides: <u>296' / 186'</u> rear: <u>4</u>	51' □ Subdivision (# of Lots:)
ADDITIONAL MUNICIPAL P		 Boundary Line Adjustment (BLA) Planned Unit Development (PUD)
	ldress Request	Parking Lot
□ Water & Sewer Allocation 🛛 🖄 none of	the above	- Oail/and/morel/mineral extraction

Date created: Oct-Nov 2012 / Revised: July 2019

[Additional State Permits may also be required]

- ior
- р

- □ Soil/sand/gravel/mineral extraction
- □ Other

Date:04.	5. 2022 Application #: 038-22
	300 - + \$15 recording fee = 315
Parcel ID #:	
Tax Map #:	14-065.012

SKETCH PLAN

Exhibit A2

Please include a sketch of your project, drawn to scale, with all required measurements - see *Zoning Permit Application Instructions*. You may use the space below or attach separate sheets. For plans larger than 11"x17" please provide a digital copy (pdf. file format) in addition to a paper copy.

SEE ATTACHED SITE PLAN

SIGNATURES The undersigned hereby applies for a Zoning Permit for the use described in this application to be issued on the basis of the representations made herein all of which the applicant swears to be complete and true.

Questi a. Brow illum P. Brocon	4/15/22
Applicant Signature	date '
Justin a. Brow Man P. Brown	4/15/2-
Property Owner Signature	date

CONTACT Zoning Administrator Phone: (802) 244-1018 Mailing Address: Waterbury Municipal Offices, 28 North Main Street, Suite 1, Waterbury, VT 05676 Municipal Website: www.waterburyvt.com

OFFICE USE ONLY	
Zoning District/Overlay:	REVIEW/APPLICATIONS:
Review type: Administrative DRB Public Warning Required: Yes No DRB Referral Issued (effective 15-days later):	Conditional Use Waiver Site Plan Variance
DRB Mtg Date: Decision Date:	Subdivision:
Date Permit issued (effective 18-days later):	G Subdy. G BLA G PUD
Final Plat due (for Subdivision only):	Overlay:
Remarks & Conditions:	DDR D SFHA D RHS D CMP Sign Other
Authorized signature:Date:	⊡ n/a

TOWN OF WATERBURY SITE PLAN REVIEW INFORMATION

Date:	Application #:
Fees Paid:	(\$15 recording fee already paid)
Parcel ID #:	
Тах Мар #:	

This Site Plan Review information sheet supplements the Zoning Permit Application. Please provide all of the information requested on both forms. Read the Zoning Regulations and familiarize yourself with the requirements. Failure to provide all the required information will delay the process. Submit one copy of the completed forms and a check payable to the *Town of Waterbury* according to the zoning fee schedule. For questions about the permit process please contact the Zoning Administrator at 802-244-1018.

PROJECT DESCRIPTION

Brief description of project: <u>Construction of single-family residence with associated infrastructure</u>

SITE PLAN REVIEW CRITERIA

Please utilize the check list to ensure your proposal addresses each relevant Site Plan Review criteria:

- \underline{X} Adequacy of traffic access
- X Adequacy of circulation and parking
- X Adequacy of landscaping and screening (including exterior lighting)
- _____ Requirements for the Route 100 Zoning District
- _____ Special considerations for projects bordering Route 2, Route 100, or Interstate 89

SITE PLAN SUBMISSION REQUIREMENTS

Before an application for site plan review is considered complete, the applicant shall file a site plan, clearly drawn to the largest practical scale, showing the following:

- Location and dimensions of lot lines, names of adjacent landowners, all easements, utilities, and existing and proposed structures.
- All access to public streets or roads, parking and service areas, pedestrian walkways, curbs and stormwater drainage.
- Pedestrian and vehicular circulation, including parking lot layout, entrances to structures, signs, and lighting.
- Building elevations and footprints.
- 🕱 Detailed site grading and landscaping, indicating existing and proposed trees, shrubs, and ground cover.
- \mathbf{x} Two copies of all plans.
- For plans larger than 11"x17" please submit a digital plan set in addition to the paper copy (pdf. file format).

CONTACT Zoning Administrator Phone: (802) 244-1018

Mailing Address: Waterbury Municipal Offices, 28 North Main Street, Suite 1, Waterbury, VT 05676 Municipal Website: www.waterburyvt.com

TOWN OF WATERBURY OVERLAY DISTRICT INFORMATION

Date:	Application #:
Fees Paid:	(\$15 recording fee already paid)
Parcel ID #:	
Tax Map #:	

This Overlay District information sheet supplements the Zoning Permit Application. Please provide all of the information requested on both forms. Read the Zoning Regulations and familiarize yourself with the requirements. Failure to provide all the required information will delay the process. Submit one copy of the completed forms and a check payable to the *Town of Waterbury* according to the zoning fee schedule. For questions about the permit process please contact the Zoning Administrator at 244-1018.

PROJECT DESCRIPTION

Brief description of project: <u>Construction of single-family residence with associated infrastructure</u>

Fill out only the relevant section(s) & utilize the following checklists to ensure your plans include all the required information.

DOWNTOWN DESIGN REVIEW OVERLAY DISTRICT (DDR)

DESIGN STANDARDS:

For Historic Structures (applying to all structures listed on the National Register of Historic Places):

- Original materials or materials typical of the architectural style are preserved or replaced with like materials to the extent feasible and appropriate.
- Historic building features shall be preserved or replicated to the extent feasible and appropriate.

For projects within the Historic/Commercial Sub-District:

- New building designs shall reinforce historic streetscape patterns, including orientation and setbacks.
- New buildings shall maintain overall height, size, massing, scale, and proportions compatible with those of buildings in the vicinity.
- New additions are designed to complement and be compatible with the original structure.
- □ Project design reinforces a pedestrian streetscape.
- On-site utilities shall be buried and utility boxes are screened from public view if the utilities along the street serving that structure are also buried.
- Buildings, or portions thereof, having eaves heights of 20feet or less above ground level incorporate moderately to steeply pitched roofs, unless the another roof type is appropriate.

For projects within the Mixed-Use Sub-District:

- Building sites, including road and pedestrian networks, are designed in a manner that is integrated and compatible with adjoining parcels and areas.
- A proposed project located next to or facing a historic structure incorporates similar or complementary building features.
- New buildings are oriented to front upon, and relate both functionally and visually to, primary access roads.
- On-site parking is situated to the rear or on the sides of structures, where feasible and appropriate.
- The primary facades of principal structures are clearly defined through the placement of one or more prominent entryways, pedestrian walkways, or landscaping features.
- Building facades and rooflines are designed so as to reduce the perceived mass, scale, and uniform impersonal appearance of large buildings and additions, and to provide visual interest.
- Clearly defined pedestrian walkways are provided through parking areas, between buildings, and from public sidewalks to the site.

- SUBMISSION REQUIREMENTS:
- All information required under Site Plan (see Site Plan Application)
- Proposed architectural elevations (for each exterior wall) showing door and window types and placement, and other exterior details
- □ A description of all materials to be used on the exterior of building
- □ Photos of the existing building(s) on the site and adjacent and facing parcels
- □ For demolition of a structure listed on the National Register of Historic Places see additional requirements within the Regulations.

RIDGELINE, HILLSIDE, STEEP SLOPE OVERLAY DISTRICT (RHS)

REVIEW STANDARDS:

- X For both Minor & Major Development Projects see Conditional Use Criteria
- ___ For Major Development Projects:
 - ____ Screening
 - ___ Access
 - ____ Placement of Structures
 - ____ Exterior Lighting
 - ____ Clearcutting and Pre-Development Site Preparation
 - ____ Natural Resources
 - ____ Building Design

SUBMISSION REQUIREMENTS :

- X Minor Development Projects (1,200–1,499 FIE)
 - All information required under Site Plan
 Review (see Site Plan Review Application)
 - Completed Conditional Use Application
 - ____ Major Development Projects (1,500 & up FIE)
 - All information required under Site Plan
 Review (see Site Plan Review Application)
 - Completed Conditional Use Application
 - □ Grading Plan
 - D Visibility Studies
 - Stormwater Drainage/Erosion Control Plan
 - Landscape Plan
 - □ Access Plan □ Natural Features

SPECIAL FLOOD HAZARD AREA OVERLAY DISTRICT (SFHA)

DESIGN STANDARDS:

_____ All development is reasonably safe from flooding _____ All fuel storage tanks are either elevated or floodproofed. All substantial improvements and new construction (including fuel storage tanks) meet the following criteria:

- ____ Designed, operated, maintained, modified and adequately anchored to prevent flotation, collapse, release, or lateral movement of the structure
- ____ Constructed with materials resistant to flood damage
- Constructed by methods and practices that minimize flood damage
- Constructed with electrical, heating, ventilation, plumbing and air-conditioning equipment and other service facilities that are designed and/or located so as to prevent water from entering or accumulating within the components during conditions of flooding
- All new subdivisions and other proposed developments that are greater than 50 lots or 5 acres, whichever is the lesser shall include within such proposal base flood elevation data. See Regulations for additional subdivision standards.
- The fully enclosed areas below the lowest floor that are useable solely for parking of vehicles, building access, or storage in an area other than a basement are designed to automatically equalize hydrostatic flood forces on exterior walls by allowing for the entry and exit of floodwaters.
- A non-residential, appurtenant structure of 500 sf or less need not be elevated to or above the base flood elevation in this area, provided the structure is placed on the building site so as to offer the minimum resistance to the flow of floodwaters
- In Zones AE, A, and A1 A30 where base flood elevations and/or floodway limits have not been determined, new construction and substantial improvement shall not be permitted unless it is demonstrates additional standards (see Regulations)
- All new construction and substantial improvements of residential structures within Zones A1-30, and AE must have the lowest floor of all residential structures (including basement) elevated to at least one foot above the base flood level.
- All manufactured homes are installed using methods and practices which minimize flood damage. Manufactured homes must be elevated on a permanent foundation such that the lowest floor of the manufactured home is at least one foot above base flood elevation, and they must be anchored to an adequately anchored foundation to resist flotation collapse, or lateral movement.
- ____ All new construction and substantial improvements of non-residential structures within Zones A1-30, and AE shall:
- Have the lowest floor (including basement) elevated to at least two feet above the base flood level; or
- Be designed so that below the base flood level the structure is water tight with walls substantially impermeable to the passage of water with structural components having the capability of resisting hydrostatic and hydrodynamic loads and

effects of buoyancy to a point at least two feet above the base flood level.

- U Where a non-residential structure is intended to be made watertight below the base flood level a registered
- □ professional engineer or architect shall develop and/or review structural design
- Adequate drainage paths shall be required around structures on slopes to guide floodwaters around and away from proposed structures.
- _____ The flood carrying and sediment transport capacity within the altered or relocated portion of any watercourse shall be maintained, and any alteration or relocation shall not result in any decrease of stream stability.
- Bridge and culverts, which by their nature must be placed in or over the stream, must obtain a stream alteration permit from the Agency of Natural Resources, if required.

SUBMISSION REQUIREMENTS:

- Plans in triplicate, drawn to scale, showing the location, dimensions, contours, and elevation of the lot; the size and location on the site of existing or proposed structures, fill or storage of materials; the location and elevations of streets, water supply, and sanitary facilities; and the relation of the above to the location of the channel, floodway, and base flood elevation
- Specifications for building construction and materials, floodproofing, mining, dredging, filling, grading, paving, excavation, or drilling, channel improvement, storage of materials, water supply, and sanitary facilities
- Base flood elevation data for all subdivisions, new construction, and substantial improvements
- The elevation, in relation to mean sea level, of the lowest floor, including basement, of all new construction or substantial improvement of structures
- Where floodproofing is used in lieu of elevation, the elevation, in relation to mean sea level, to which any structure or substantial improvement will be floodproofed

- Where an application requires Board review the application shall include certification by a registered professional engineer or architect demonstrating that the proposed development will not increase base flood elevations more than 0.25 foot
- Certification by a registered professional engineer or architect demonstrating compliance with the elevation requirements
- A description of the extent to which any watercourse will be altered or relocated as a result of the proposed development
- A Vermont Agency of Natural Resources Project Review Sheet for the proposal
- Proposed floodproofing must be supported by a FEMA Floodproofing Certificate

CERTIFICATE OF COMPLETION: Upon completing the project the Applicant must apply for and receive a Certificate of Completion to ensure the project conforms to the Special Flood Hazard Area Regulations. See Certificate of Completion Application for additional information.

CONTACT Zoning Administrator Phone: (802) 244-1018 Mailing address: Waterbury Municipal Offices, 28 North Main Street, Suite 1, Waterbury, VT 05676 Municipal Website: www.waterburyvt.com

Exhibit B1

TOWN OF WATERBURY CONDITIONAL USE INFORMATION

This Conditional Use (and Setback Waiver) information sheet	
supplements the Zoning Permit application. Please provide all of	

Date:	Application #:
Fees Paid:	(\$15 recording fee already paid)
Parcel ID #:	
Тах Мар #:	

the information requested on each form. Read the Zoning Regulations and familiarize yourself with the requirements. Failure to provide all the required information will delay the process. Submit one copy of the completed forms and a check payable to the *Town of Waterbury* according to the zoning fee schedule. For questions about the permit process, please contact the Zoning Administrator at 802-244-1018.

PROJECT DESCRIPTION

Brief description of project: <u>Construction of single-family residence with associated infrastructure</u>

CONDITIONAL USE CRITERIA

Please respond to the following; you may answer on a separate sheet and attach additional pages and supporting materials:

 Describe how the proposed use will not have an undue adverse impact on the capacity of existing or planned community facilities to accommodate it (including roads and highways, municipal water or sewer systems, school system, fire protection services):

See attached response letter

2. Describe how the proposed use will not have an undue adverse impact on the character of the area affected as defined by the Municipal Plan and the zoning district in which the proposed project is located:

See attached response letter

3. Describe how the proposed use will not violate any municipal bylaws and ordinances in effect:

See attached response letter

4. Describe any devices or methods to prevent or control fumes, gas, dust, smoke, odor, noise, or vibration:

See attached response letter

5. For removal of earth or mineral products which is not incidental to a construction, landscaping, or agricultural operation, a removal project must meet specific conditions outlined within Section 302 of the Waterbury Zoning Regulations. Are the conditions included within the Application Submittals?

See attached response letter

CONTACT Zoning Administrator Phone: (802) 244-1018 Mailing Address: Waterbury Municipal Offices, 28 North Main Street, Waterbury, VT 05676 Municipal Website: www.waterburyvt.com

Exhibit B2

Brown Proposed House Construction, Bear Creek Lane Response to Conditional Use Criteria, Waterbury Zoning Regulations

(1) The proposed use will not adversely affect the capacity of existing or planned community facilities to accommodate it. For community facilities, the proposed use:

- A. will not cause the level of service on roads and highways to fall below a reasonable standard The addition of one single-family residence in this rural/residential area of town will not generate traffic volumes that would cause an undue adverse impact to existing infrastructure.
- B. will not cause an unmanageable burden on municipal water or sewer systems not applicable as connection to municipal systems are not proposed.
- C. will not lead to such additional school enrollments that existing and planned school system capacity is exceeded the one proposed single-family residence will not result in a number of students which will exceed the school system capacity.
- D. will not cause an unmanageable burden on fire protection services the addition of one new structure in this undeveloped area will not cause an unmanageable burden on fire protection services.

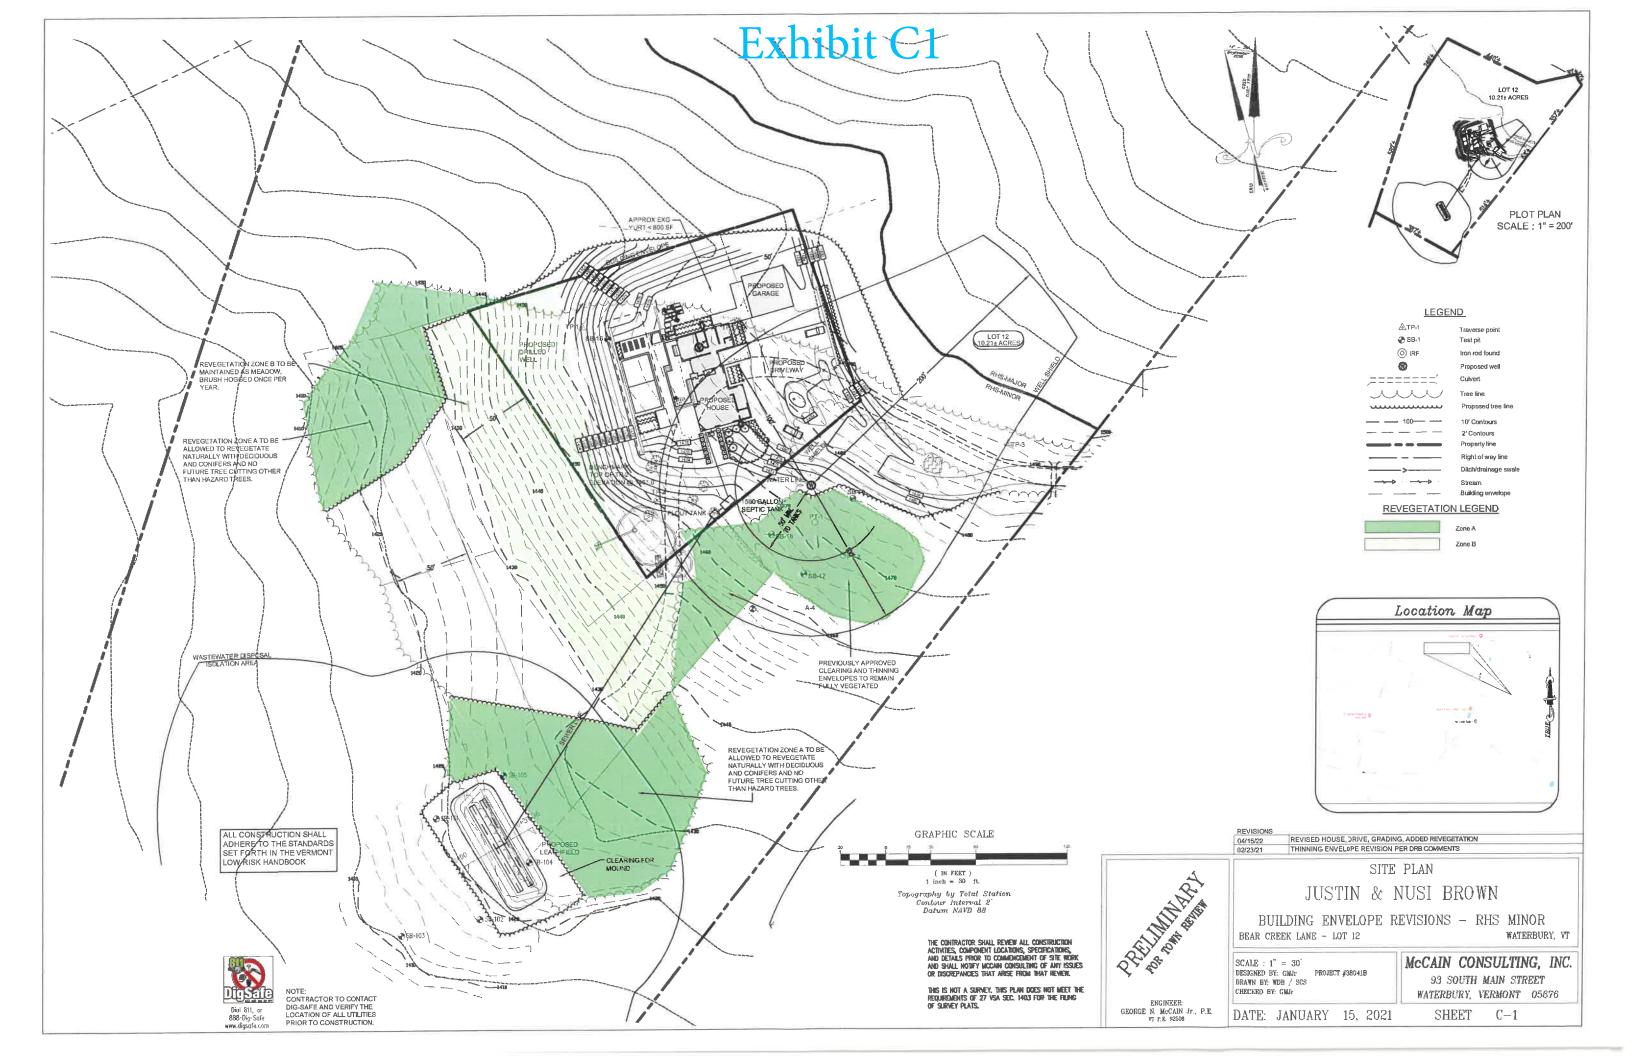
(2) The proposed use will not adversely impact the character of the area affected. Specifically, the proposed use:

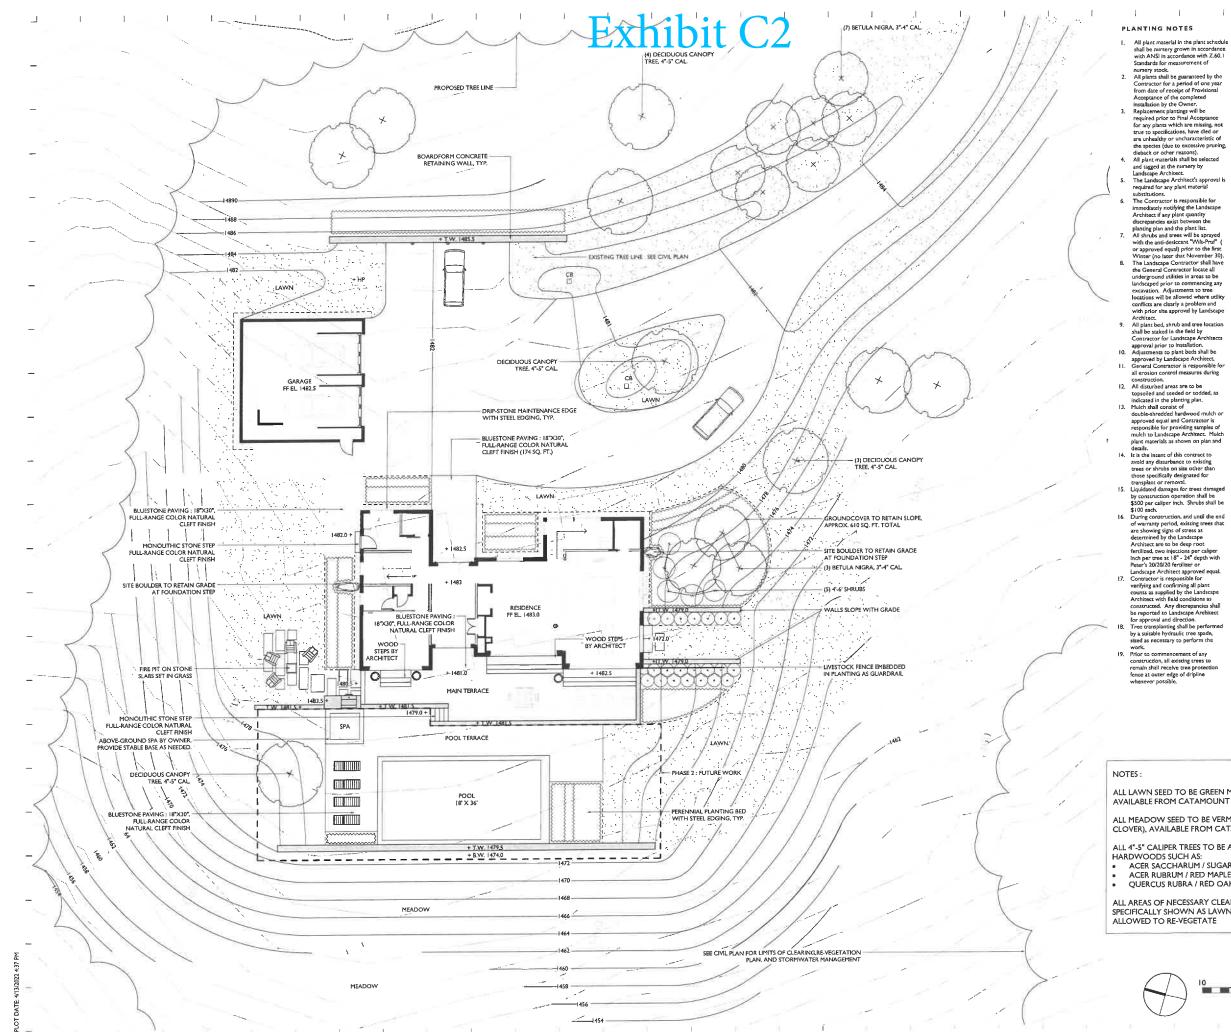
- A. will not result in undue water pollution, undue adverse impacts to downstream properties, and will not cause unreasonable soil erosion or reduction in the capacity of the land to hold water so that a dangerous or unhealthy condition may result the addition of this structure will not result in the above adverse conditions. Erosion prevention and sedimentation control measures will be utilized during the development of the lot. Construction will adhere to the standards set forth in the Vermont Low-Risk Handbook.
- B. will not result in undue noise, light, or air pollution, including offensive odors, dust, smoke, or noxious gasses the addition of one single-family house will not result in the above adverse conditions. Light and noise conditions will be typical of standard residential use.
- C. will not have an undue adverse effect on the scenic or natural beauty of the area, historic sites, or rare and irreplaceable natural areas We are aware of no historic sites or rare or irreplaceable natural areas on the parcel. The State of Vermont does not identify any rare, threatened, or endangered species, or deer wintering areas on the parcel.
- D. will not be otherwise inconsistent with existing uses in the immediate area The project as proposed is a continuation of existing low density residential development in the direct vicinity.
- E. will not cause danger of fire, explosion, or electrical hazard, or in any other way jeopardize the health and safety of the area the addition of a single-family house will not cause the above-listed dangers.

(3) The proposed use will not violate any municipal bylaws and ordinances in effect – single-family houses are a permitted use within the Conservation District, and are a conditional use within the Ridgelines/Hillsides/Steep slope (RHS) Overlay District.

(4) The proposed use will comply with the specific lot area, setbacks, and lot coverage requirements set forth in this Bylaw – minimum lot size, setback, and lot coverage requirements are met.

(5) For removal of earth or mineral products which is not incidental to a construction, landscaping, or agricultural operation, a removal project must meet specific conditions outlined within Section 302 of the Waterbury Zoning Regulations. Are the conditions included within the Applications Submittals? – N/A, this is not an earth removal operation.





All plant material in the plant schedule All planc material in the planc schedule shall be nursery grown in accordance with ANSI in accordance with Z.60.1 Standards for measurement of nursery stock. All plants shall be guaranteed by the Contractor for a period of one year from date of receipt of Provisional Acceptance of the completed installation by the Owner. Replacement planting will be required prior to Final Acceptance for any plans with are missing, not

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for any plants which are missing, not true to specifications, have died or are unhealthy or uncharacteristic of the species (due to excessive pruning,

dieback or other reasons). All plant materials shall be selected

and tagged at the nursery by Landscape Architect. The Landscape Architects approval is required for any plant material

required for any plant material substitutions. The Contractor is responsible for immediately notifying the Landscape Architest if any plant quantity discrepancies exist between the planting plan and the plant list. All shrubs and trees will be sprayed with the and i-desictant "With-Prd" (or approved equal) prior to the first Wither (no laser that November 30). The Landscape Contractor shall have the General Contractor totate all underground utilities in areas to be landscaped prior to commencing any excavation. Adjustments to tree locations will be allowed where utility conflicts are clearly a problem and conflicts are clearly a problem and with prior site approval by Landscape

with prior size approval by Landscape Architect. All plant bed, shrub and tree location shall be stacked in the field by Contractor for Landscape Architects approval prior to Installation. Adjustments to plant beds shall be approved by Landscape Architect. General Contractor is responsible for all erosion control measures during construction.

construction.
 All disturbed areas are to be topsoiled and seeded or sodded, as indicated in the planting plan.
 Mulch shall consist of

double-shredded hardwood mulch or

approved equal and Contractor is responsible for providing samples of mulch to Landscape Architect. Mulch plant materials as shown on plan and

It is the intent of this contract to

fertilized, two injections per caliper inch per tree at 18" - 24" depth with Peter's 20/20/20 fertilizer or

TREE PROTECTION NOTES

WAGNERHODGSON

n 12534

NYS 8367

LANDSCAPE AR

0 Warren

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Proposed methods, and schedule for effecting tree and plant protection shall be submitted for approval. Proposed methods, materials, and schedule

Proposed methods, materials, and schedule for root pruning, somtruction pruning, and true fordication shall be submitted for approval. Corrain specimem cress adjecent to construction areas and in other key locations will be identified by the Owner and the Architers, and marked with rel aga. Loss of any of discs trees will real in finite assessed at \$5,000 per exe. Drange on a locher trees on the property wile satisfied and trees on the property and be antested as the Constructor for each incident of construction inder use propercion areas.

A fiele of \$1.500 will be reveal spins: the Converse for each incides of originst the Converse for each incides of originst the Damages to trees, shruks, and other vegetation will be assessed by the Architect and Owner in accordiants with the Context Interface of the Context of the Context Interface of the Context of the Context of the Context of the Context of the requirements: reputated above for a period of the one period the Context of the the Context of the Context of the Context of the tree of the Context of the Context of the tree of the Context of the Context of the tree of the Context of the Context of the tree of the Context of the Context of the tree of the Context of the Context of the tree of the Context of the Context of the tree of the Context of the Context of the tree of the Context of the Context of the tree of the Context of the Context of the tree of the Context of the Context of the tree of the Context of the Context of the tree of the Context of the Context of the tree of the Context of the Context of the tree of the Context of the Context of the tree of the Context of the Context of the tree of the Context of the Context of the tree of the Context of the Context of the tree of the tree of the Context of the tree of the tree of the Context of the Context of the tree of the tree of the Context of the Context of the tree of the tree of the Context of the Context of the tree of the tree

preserves. Designated areas of trees, understory, and wildflowers are to remain unpouched and

unharmed. Clearly mark all clearing limits in the field and accompany Architect on a joint review of accompany Architect on a joint review of clearing limits before clearing operations have commenced. Limit of clearing is generally defined as the limit of grading.

stensed as the limit of grading. Galvanized chain link fencing, 4 fock high. Scakes for fencing shall be 8 feet galvanized stael potst, driven a minimum of 3 feet into the ground. Posts shall be spaced 10 feet on center maximum.

the ground ress into the pace of recom-center maximum. Prior to start of demolston work and clearing and grubbing operations, the procession feacing shall be installed in accordance with the following: Fencing shall be installed at the tree

13

rencing shall be installed at the Cree protection areas indicated on the Drawings. Fencing shall be installed a minimum of 15 feet beyond the drip line of the trees to be protected, unless otherwise approved by the Architect. Where construction will be in close

venere construction will be in close proximity to existing trees designated to remain, noots shall be pruned. Proximity shall be as determined in the field by the Landscape Architect or Arbonist.

Suitable means for root pruning include,tranching, vibrating plow, and water jet pruning. Any method which tears roots or disturbs the soil beyond the grading limit is

inacceptable. Trees to receive root pruning shall be reviewed by an arborist for canopy pruning, fertilization and trench backfill recommendations.

To construct many time of the second many time to the second many time to the second many time of the work that he many many time of the second many term of the second many term of the second many time of the second many term of the second many time of the second many term of the second many time of the second many term of the second many t

DESCRIPTION

NO.

DATE

ISSUED FOR

PERMIT

BROWN RESIDENCE WATERBURY CENTER, VT

ALL LAWN SEED TO BE GREEN MOUNTAIN SPECIAL MIX, AVAILABLE FROM CATAMOUNT SEED / L.D. OLIVER.

ALL MEADOW SEED TO BE VERMONT CONSERVATION MIX (NO CLOVER), AVAILABLE FROM CATAMOUNT SEED / L.D. OLIVER.

ALL 4"-5" CALIPER TREES TO BE A MIX OF NATIVE DECIDUOUS HARDWOODS SUCH AS: ACER SACCHARUM / SUGAR MAPLE ACER RUBRUM / RED MAPLE

QUERCUS RUBRA / RED OAK

ALL AREAS OF NECESSARY CLEARING AND RE-GRADING NOT SPECIFICALLY SHOWN AS LAWN OR MEADOW TO BE ALLOWED TO RE-VEGETATE

> 10 0 SCALE OF FEET

LANDSCAPE PLAN

IOB NO. 21-138 SCALE: I"=10'-0" DRAWN BY: CS 04.13.2021 DATE:

.000

Exhibit D1



ZONING NOTES

ZONE: CNS CONSERVATORY ZONING DISTRICT MAX BLIILDING HEIGHT, 35 FT MIN. FRONT YARD: 100 FT MIN. SIDE YARD: 100 FT MIN. REAR YARD: 100 FT

SQUARE FOOTAG	E ANALYSIS
ABOVE GRADE CONDIT	IONED
FIRST FLOOR	1857 SF

SECOND FLOOR 1458 SF 3315 SF BELOW GRADE CONDITIONED 1281 SF 1281 SF

HARDSCAPE/DECK COVERED ENTRY COVERED LINK ENTRY TERRACE 118 SF 356 SF 67 SF 858 SF 1397 SF MAIN TERRACE

OTHER GARAGE (IST FLOOR ONLY) 784 SF LOWER LEVEL - 576 SF UNFINISHED/MECHANICAL 1360 SF

Brown Residence

DRA	WING LIST
	Cover Sheet
A0 C1	Civil Plan
L000 A0 1	Landscape Plan Model Images
	Moder images First Floor Overa8 Plan
A2.0	Basement Floor Plan
A2.1	
A2.2	First Floor Plan
A2.3	First Floor Plan - Garage
A2.4	Second Floor Plan
A3.1	Overall Building Elevation
A3 2	Building Elevations
A3.3	Building Elevations
E1.0	Exterior Lighting Plan
GENE	ERAL NOTES
1	ALL DIMENSIONS ARE TO FACE OF FRAMING, UNLESS
2.	DISCREPANCIES IN DIMENSION OR LAYOUT SHALL BE BROUGHT TO THE ATTENTION OF ELD BEFORE PROCEEDING WITH CONSTRUCTION.
3.	ALL MANUFACTURED ARTICLES, MATERIALS, AND EQUIPMENT SHALL BE APPLIED, INSTALLED, CONNECTED ERECTED, USED, CLEANED, ADJUSTED, AND CONDITIONS as OPECTED BY THE MANUFACTURER UNITERS

ERECTED. USED CLEANED ADJUSTED, AND CONDITIONED AS DRECTED BY THE MANUFACTURER UNLESS OTHERWISE SPECIFIED. ALL MATERIALS SHALL BE NEW AND UNUSED, UNLESS OTHERWISE NOTED ALL WORK SHALL BE PERFORMED IN A WORKMANLIKE MANNER. ALL DIMENSIONS NOTED TO BE "VERIFIED" SHALL BE DONE SO BY THE CONTRACTOR PRIOR TO CONSTRUCTION AND REPORTED TO ELD. ASPECTS OF CONSTRUCTION NOT FULLY SHOWN SHALL BE OF THE SAME CHARACTER AND QUALITY AS THOSE SHOWN IN SIMILAR CONDITIONS

A R Erika c. 60 erika	C H I T L. Dodge 3.770.703 @eldarch	, AIA, U 7	U R E EED AP
	wn sider	nce	
561 E	et Addres Bear Cre erbury C 7	ek Lai	
Date:			_
14 Ap Subjec	ril 2022 r: Ainor Re		

cale	1/4" = 1'-0	

Srawing Number

A0





EAST PERSPECTIVE

SOUTHEAST PERSPECTIVE



NORTHWEST PERSPECTIVE



SOUTH/SOUTHEAST PERSPECTIVE

Exhibit D2


а е с н і т е с т и Еліка L. Dodge, AIA, LEEG с. 603.770.7037	
c. 603.770.7037 erika@eldarchitecture.c	om
Brown Residence	
Project Address: 561 Bear Creek Lane Waterbury Center, V 05677	ſ
Dote: 14 April 2022	

Images

Scale:

Drawing Number:

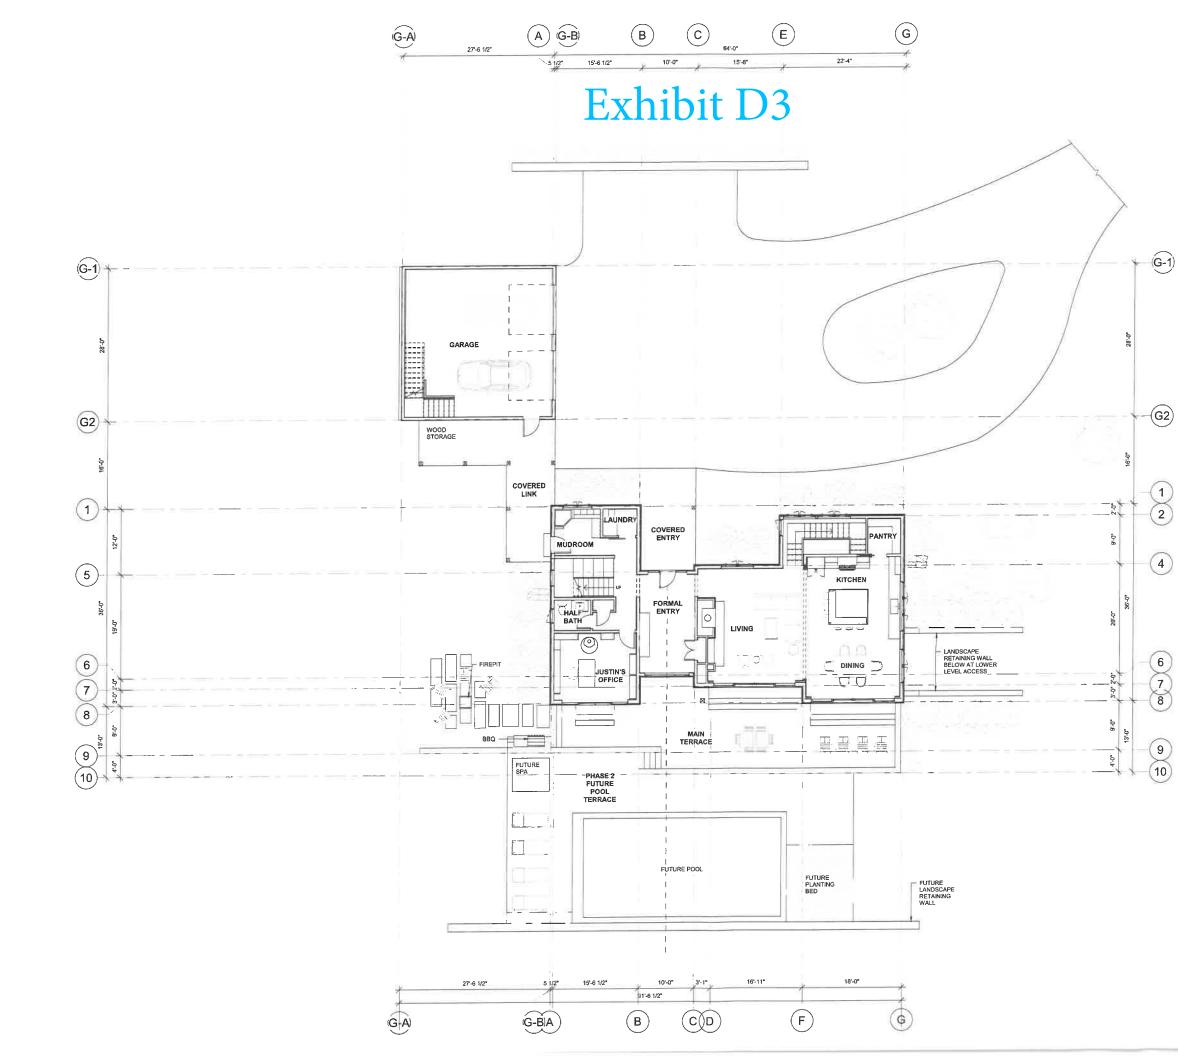A0.1



NOTES

1.

STARWAYS SERVING AN OCCUPANT LOAD LESS THAN 50 SHALL SHALL HAVE A WIDTH OF NOT LESS THAN 36 INCHES. IRC SECTION R311.7.11 STARWAYS SHALL HAVE A WIDTH OF NOT CLEARANCE OF 80 INCHES MEASURED VERTICALLY FROM A LINE CONNECTING THE EDGE OF THE NOSINGS. SUCH HEADROOM SHALL BE CONTINUOUS AGOVE THE CONNECTING THE EDGE OF THE NOSINGS. SUCH HEADROOM SHALL BE CONTINUOUS AGOVE THE STARWAY TO THE POINT WHERE THE LINE INTERSECTS THE LANDING BELOW, DNE TESTARWAY TO THE BOTTOM RISER THE MINIMUM CLEARANCE SHALL BE MAINTAINED THE FULL WIDTH OF THE STARWAY. IRC SECTION R311.7.2. WITHIN DWELLING UNITS, THE MAXIMUM TREAD DEPTH SHALL BE 1-347. THE MINIMUM RISER HEIGHT SHALL BE 1-347. THE MINIMUM RISER HEIGHT SHALL BE 1-347. THE MINIMUM RISER DEPTH SHALL BE 1-347. THE MINIMUM TREAD DEPTH SHALL BE 1-347. THE MINIMUM TREAD DEPTH SHALL BE 1-347. THE MINIMUM TREAD DEPTH

2.


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SHALL BE 10 JAVENES. INC. SEV TIMPS DETUNDS TO AND R311.74.2. INNOVALS SHALL BE GUAROPAILS AND WITHISTAND SLOBE LATERAL LODD. BI HANDONE STAT TREAD NOSINGS SHALL BE UNEDED TO WITHISTAND SLOBE LATERAL LODD. BI HANDONE STAT TREAD NOSINGS SHALL BE UNEDED TO WITHISTAND SLOBE LATERAL LODD. BI HANDONE STAT TREAD NOSINGS SHALL BE UNEDED TO WITHISTAND SLOBE LATERAL DE UNEDED TO WITHISTAND SLOBE LATERAL HANDRALLS WITH A CIRCULAR CROSS-SECTION SHALL HAVE AN OUTSIDE DIAMETER OF AT LEAST 1.25 INCHES AND NOT CREATER THAN 21 INCHES AND NOT GREATER THAN A DIS OF COIL INCH. IRC SECTION R311.77.3. HANDRALS WITHIN WELLING WITS ARE PERITTED TO BE INTERRUPTED BY A NEWEL POST AT A STAIR LANDONG, INCS SECTION R311.77.2. CLEAR SPACE BETWEEN A HANDRAL AND A WALL OR OTHER SUBRACE SHALL BE A MINIMUM OF 1.5 INCHES. PROJECTIONS INTO THE REQUIRED WIDTH OF STARWAYS AT EACH HANDRALS WITHIN UNELLING UNTS ARE PERITTED TO BE INTERRUPTED BY A NEWEL POST AT A STAIR LANDING, INCS SECTION RANDRAL SHALL NOT EXCEED 4.5 INCHES AT OR BELOW THE HANDRAL LONDING. INCS SECTION RANDRAL SHALL NOT EXCEED 4.5 INCHES AT OR BELOW THE HANDRAL INGUECTIONS INTO THE REQUIRED WIDTH OF STARWAYS WITH 4 OR MORE RISERS AS PER R311. DI GUARORALS: GUARDS SHALL FORM A PROTECTIVE BARRIER NOT LESS THAN 42 INCHES HIGH, MEASURED VERTICALLY ABOVE THE LEADING EDE OF THE TREAD ONE ADJACENT WALKING SURFACE. WITHIN DWELLING UNSA LANDWALES GUARDS SHALL HORM A PROTECTIVE BARRIER NOT LESS THAN 42 INCHES SHALL BOARD THE FEAD AND ADJACENT WALKING SURFACE. WITHIN DWELLING UNSA LANDWALES SUCH THAT A A INCHE DIAMETER SHERRE CANNOT PASS THAN 42 INCHES SHALL BOARD THE FEAD AND ADJACENT WALKING SURFACE. WITHIN DWELLING UNSA LANDWALE SURFACE WITHIN DWELLING UNSA LANDWALE SURFACE WITHIN DWELLING UNSA SHALL BOARD THE FEAD AND ADJACENT WALKING SHALL BOARD THE LEADING BUG STAR WAYS AND LAND AND ADJACENT WALKING SHALL BOARD THE LEADING BUG STAR WAYS AND LAND AND SAS THROUGH ANY OPENING. INCEGE CONTON FRAIL SECTION R32.2. OPEN GUARD SHALL BOARD THE LEADING BUG STAR WAYS AND LAND AND SAS THROUGH ANY O 3.

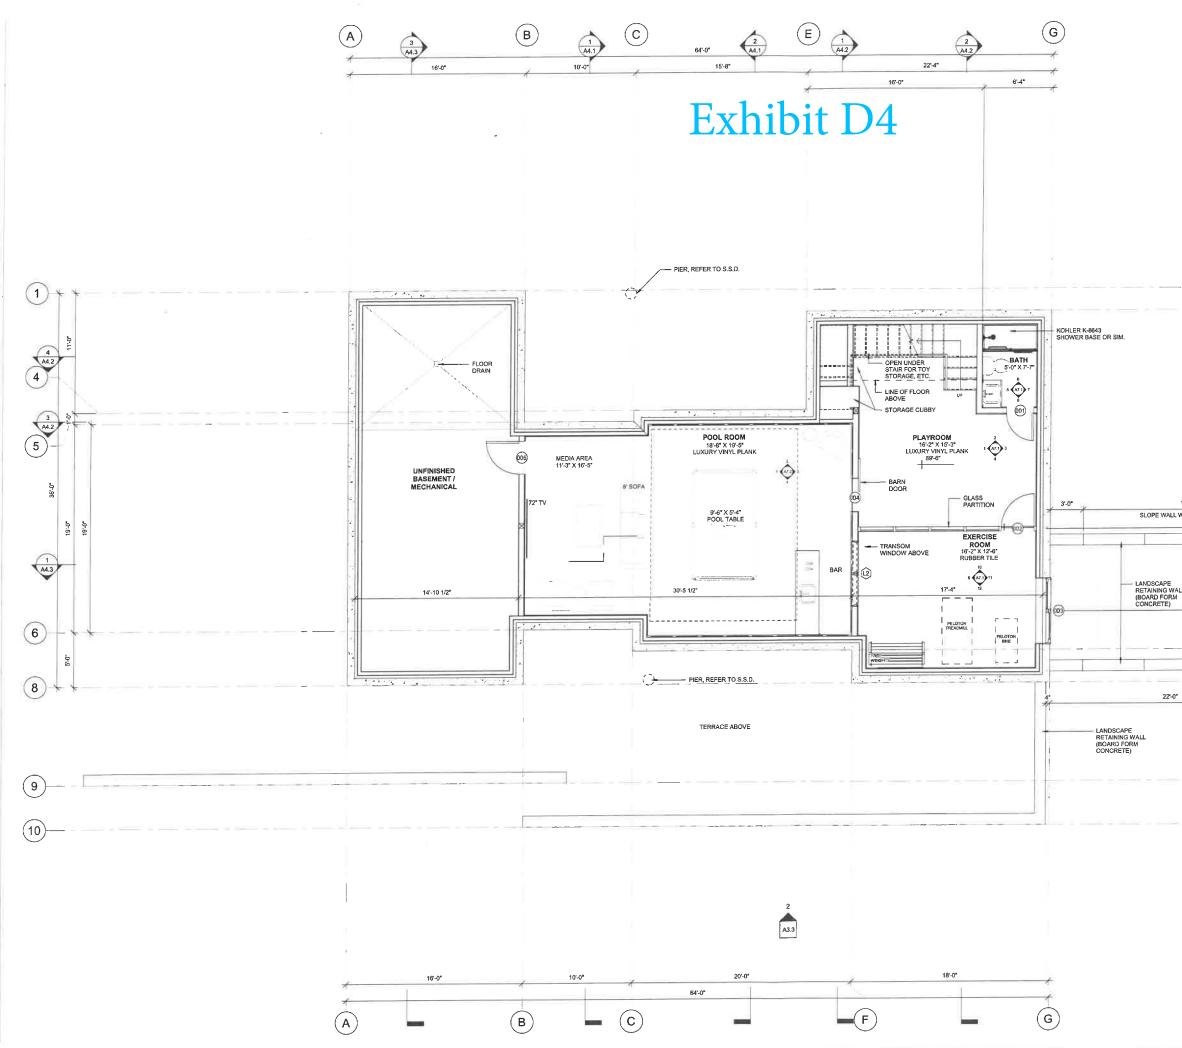ARCHITECTURE
Erika L. Dodge, AIA, LEED AP c. 603.770.7037 erika@eldarchitecture.com
Brown
Residence
Project Address: 561 Bear Creek Lane Waterbury Center, VT 05677
Dote: 14 April 2022
Subject: RHS Minor Review
Application Set Drawing Title: First Floor
Overall
Plan ^{Scole:} As indicated
Drawing Number:
A2.0





		E L Dodge, AIA, LEED AP c, 603,770,703 erika®eldarchitecture.com Brown Residence
		Project Address: 561 Bear Creek Lane Waterbury Center, VT 05677
1 (A3.3) 19-0* VITH TOPOGRAPHY	19-11 3.4* 31-0* 36-0*	
	3.6. 7.9.14. 11:0.114. 8.6. 8.6.	
	9 10	Date: 14 April 2022 Subject: RHS Minor Review Application Set Drawing Title: Baccompart
		Basement Floor Plan Scale: 1/4" = 1'-0" Drowing Number: A2.1



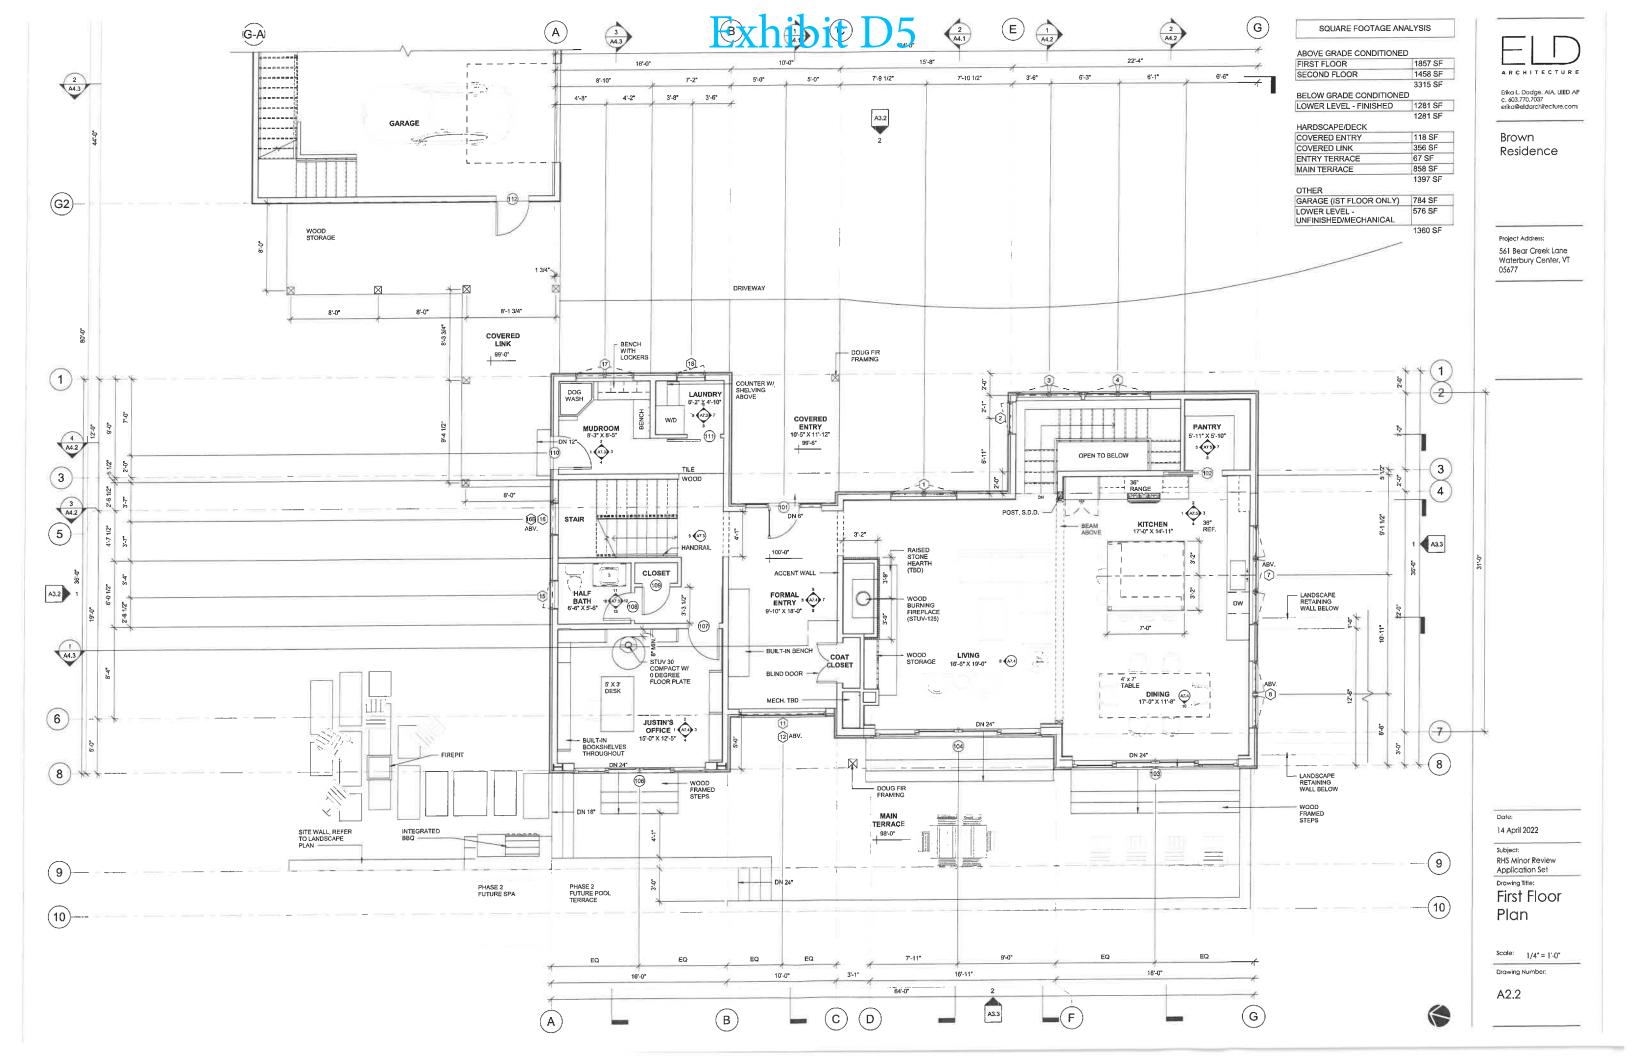


Exhibit D6

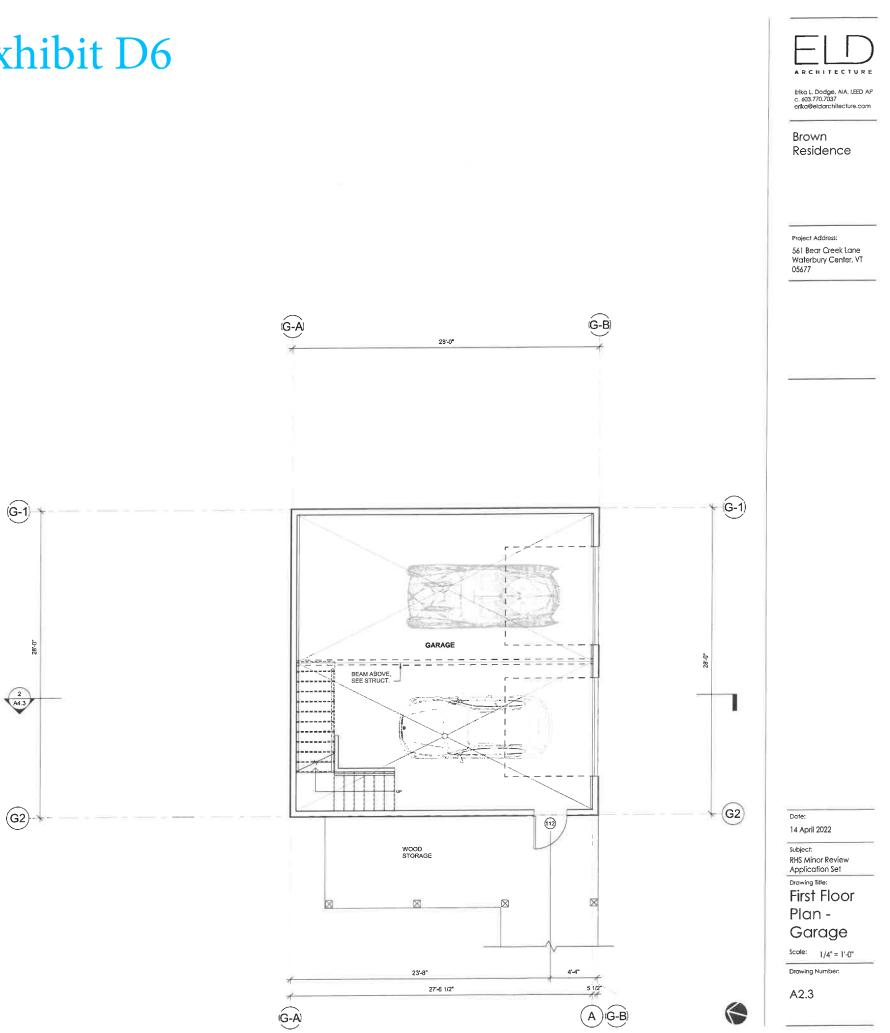

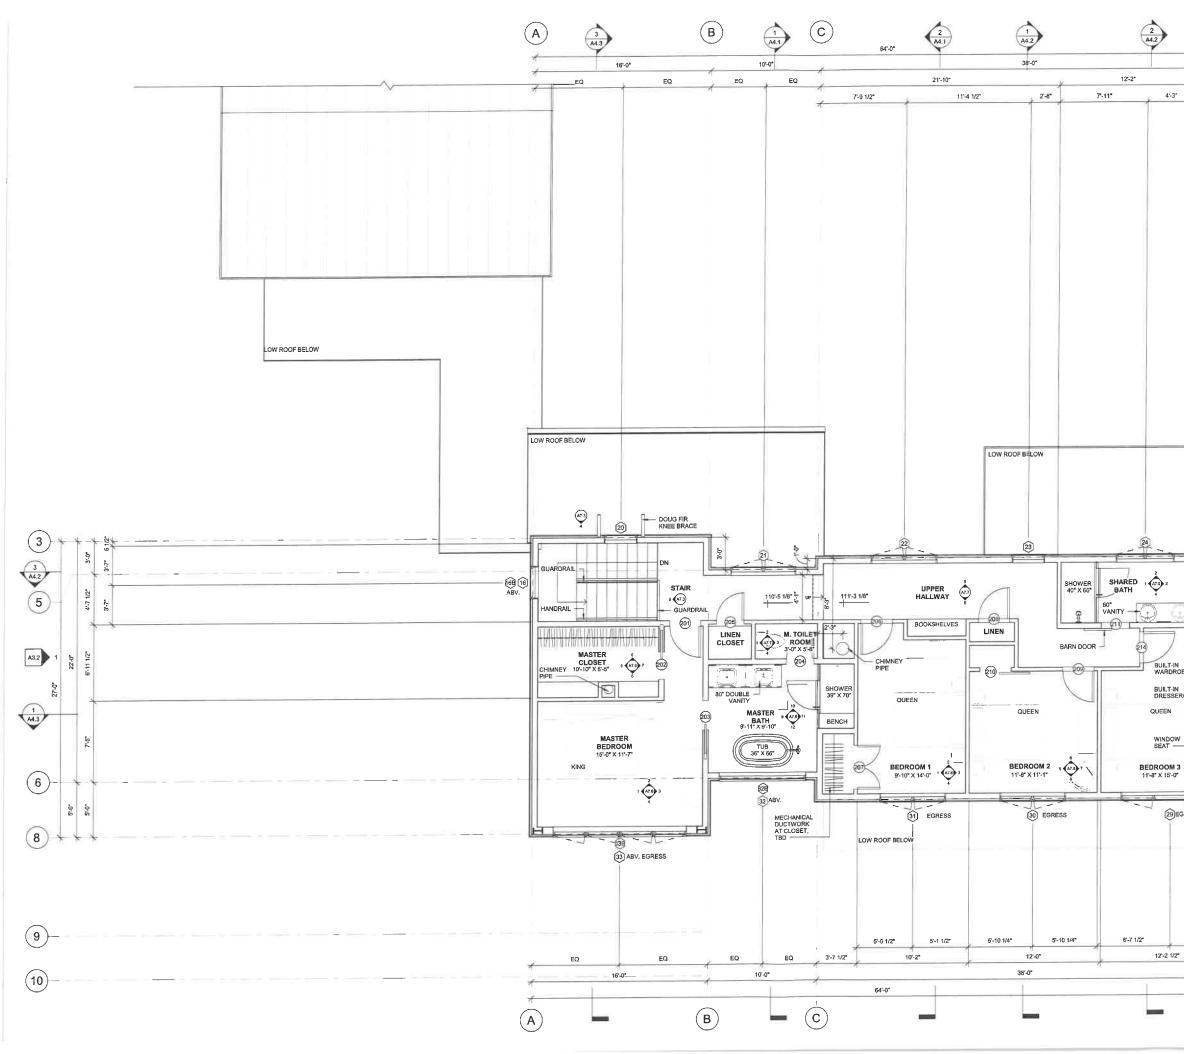

[©]Exhibit D7

4'-0"



Erika L. Dodge, AlA, LEED AP c. 603.770.7037 erika@eldarchitecture.com

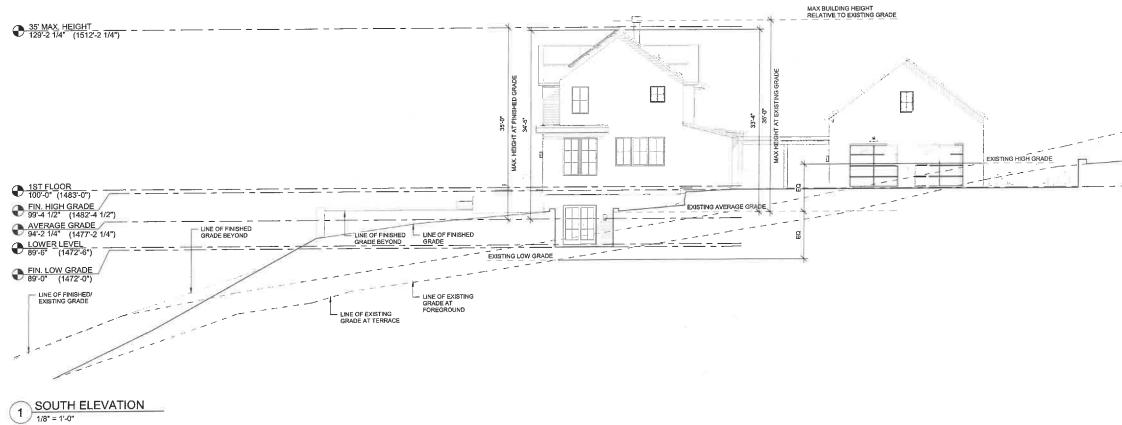
Brown Residence

Project Address: 561 Bear Creek Lane Waterbury Center, VT 05677

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JE DESK	12-5-1/2 ⁻ 15-11-1/2 ⁻ 2 ⁻¹ 0 ⁻¹
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5-10 1/2*	
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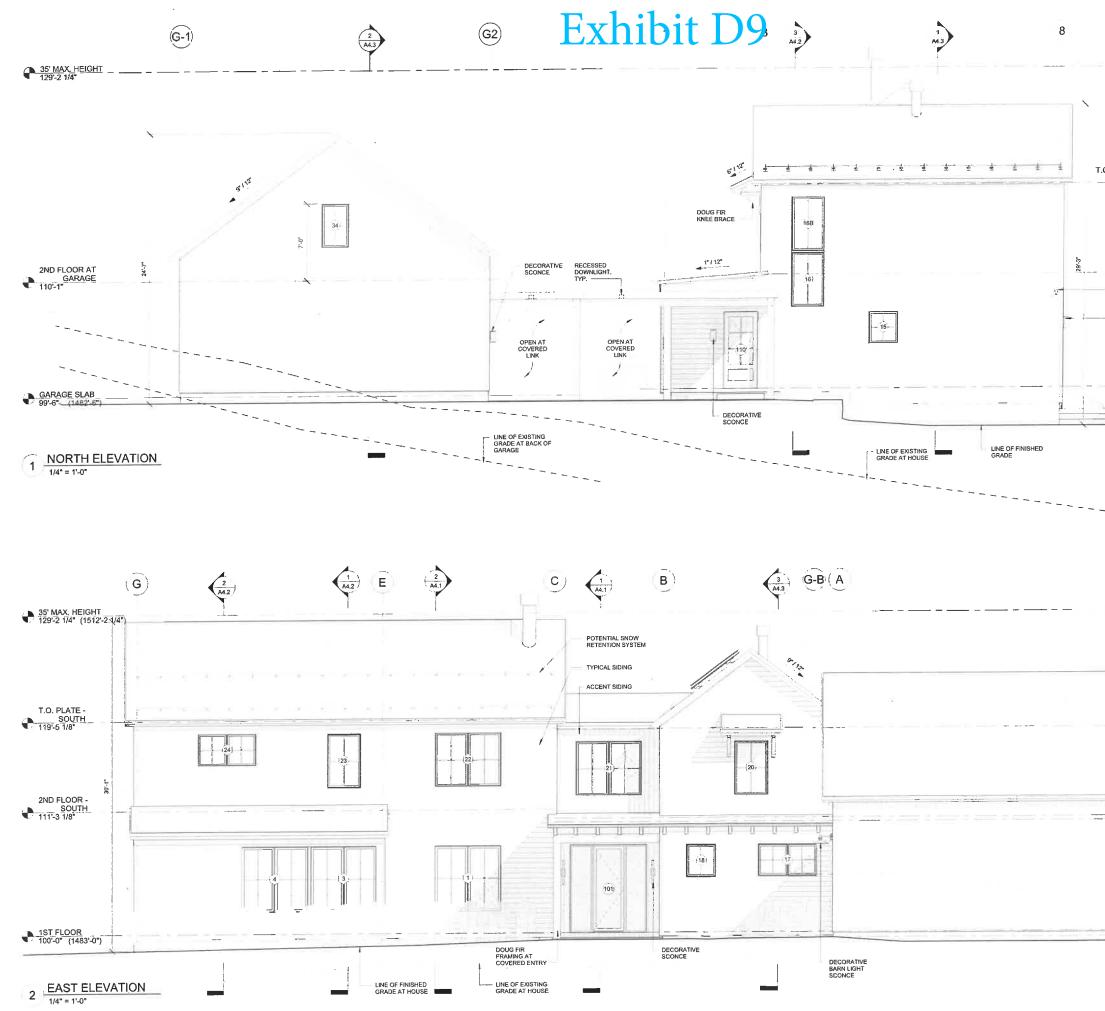
Dote:
14 April 2022
Subject: RHS Minor Review Application Set
Drawing Title: Second
Floor Plan
Scole: 1/4" = 1'-0"
Drawing Number:
A2.4

Exhibit D8






		ARCHITECTURE Erika L. Dodge. AIA. LEED AP c. 403.770.7037 erika@eldarchitecture.com Brown Residence
		Project Address: 561 Bear Creek Lane Waterbury Center, VT 05677
	LINE OF EXISTING GRADE BEYOND AT GARAGE	
LINE OF EXISTINGFINISHED GRADE	GARAGE SLAB (1482'-6") 99'-5"	
		Date: 14 April 2022 Subject: RHS Minor Review Application Set Drawing Title: Overall Building Elevation
		Scale: 1/8" = 1'-0" Drawing Number: A3.1



	EXTERIOR FINISH LEGEND	
	SIDING TYPICAL: WOOD SIDING, ASSUME CLEAR VERTICAL GRAIN HEMLOCK IN 1X6 SHIPLAP INSTALLED	FID
	HORIZONTALLY STAIN: OIL BASED, SEMI-TRANSPARENT STAIN, IN NATURAL TONE (TBD)	ARCHITECTURE
	ACCENT SIDING AND GARAGE: WOOD SIDING, ASSUME CLEAR VERTICAL GRAIN HEMLOCK IN 1X8 SHIPLAP	Brika L. Dodge, AIA. LEED AP
	INSTALLED VERTICALLY STAIN: OIL BASED, SEMI-TRANSPARENT STAIN, IN NATURAL TONE (DARK GRAY/BROWN, TBD)	c. 603.770.7037 erika@eldarchitecture.com
	WINDOWS/DOORS, MARVIN ALUMINUM/FIBERGLASS	Brown
	COLOR: EBONY ROOFING (NON-REFLECTIVE METAL): ENGLERT DOUBLE LOCK STANDING SEAM METAL 20" PANELS	Residence
	COLOR: NON-REFLECTIVE, CHARCOAL GRAY OR SIM. SOFFIT & PORCH CEILINGS: 1X T&G CEDAR	
.0. PLATE - NORTH 118'-7 1/8	STAIN: OIL BASED. CLEAR FINISH FASCIA AT FLAT ROOF: FLATSTOCK METAL	
	COLOR: NON-REFLECTIVE, COLOR TO MATCH STANDING SEAM ROOFING	
	STRUCTURAL MEMBERS: DOUGLAS FIR STAIN: OIL BASED, SEMI-TRANSPARENT STAIN, IN NATURAL TONE (DARK GRAY/BROWN, TBD)	Project Address:
	LANDSCAPE WALLS: BOARD FORMED CONCRETE	561 Bear Creek Lane Waterbury Center, VT
	TERRACES: BLUESTONE PAVERS	05677
SURFACE	AND FLOOR - NORTH 110'-5 1/8"	
DOWNCAS FIXTURE A	ST MONOPOINT	
DECORATI	VE	
FUTURE P TERRACE	OOL AND SPA	
BUILT-IN B	80	
	1ST FLOOR (1483'-0") 100'-0"	
	(1463-0) 100-0	
-G-A		
	35' MAX, HE/GHT 129-2 1/4"	
	T.O. PLATE - NORTH 118-7 1/8	
	118-7 1/8	
	2ND FLOOR -	
	$=$ $\frac{NORTH}{110'-51/8"}$	Date: 14 April 2022
	2ND FLOOR AT	Subject:
	GARAGE 110'-1"	RHS Minor Review
	VE OF EXISTING RADE AT GARAGE	Application Set Drowing Title:
		Building
	1ST FLOOR (1483'-0") 100'-0"	Elevations
	(1483-0") 100-0" GARAGE SLAB (1482-6") 99-6"	
-	(1482'-6") 99'-6"	Scale: 1/4" = 1'-0"
	NE OF FINISHED RADE AT GARAGE	Drawing Number:
		A3.2

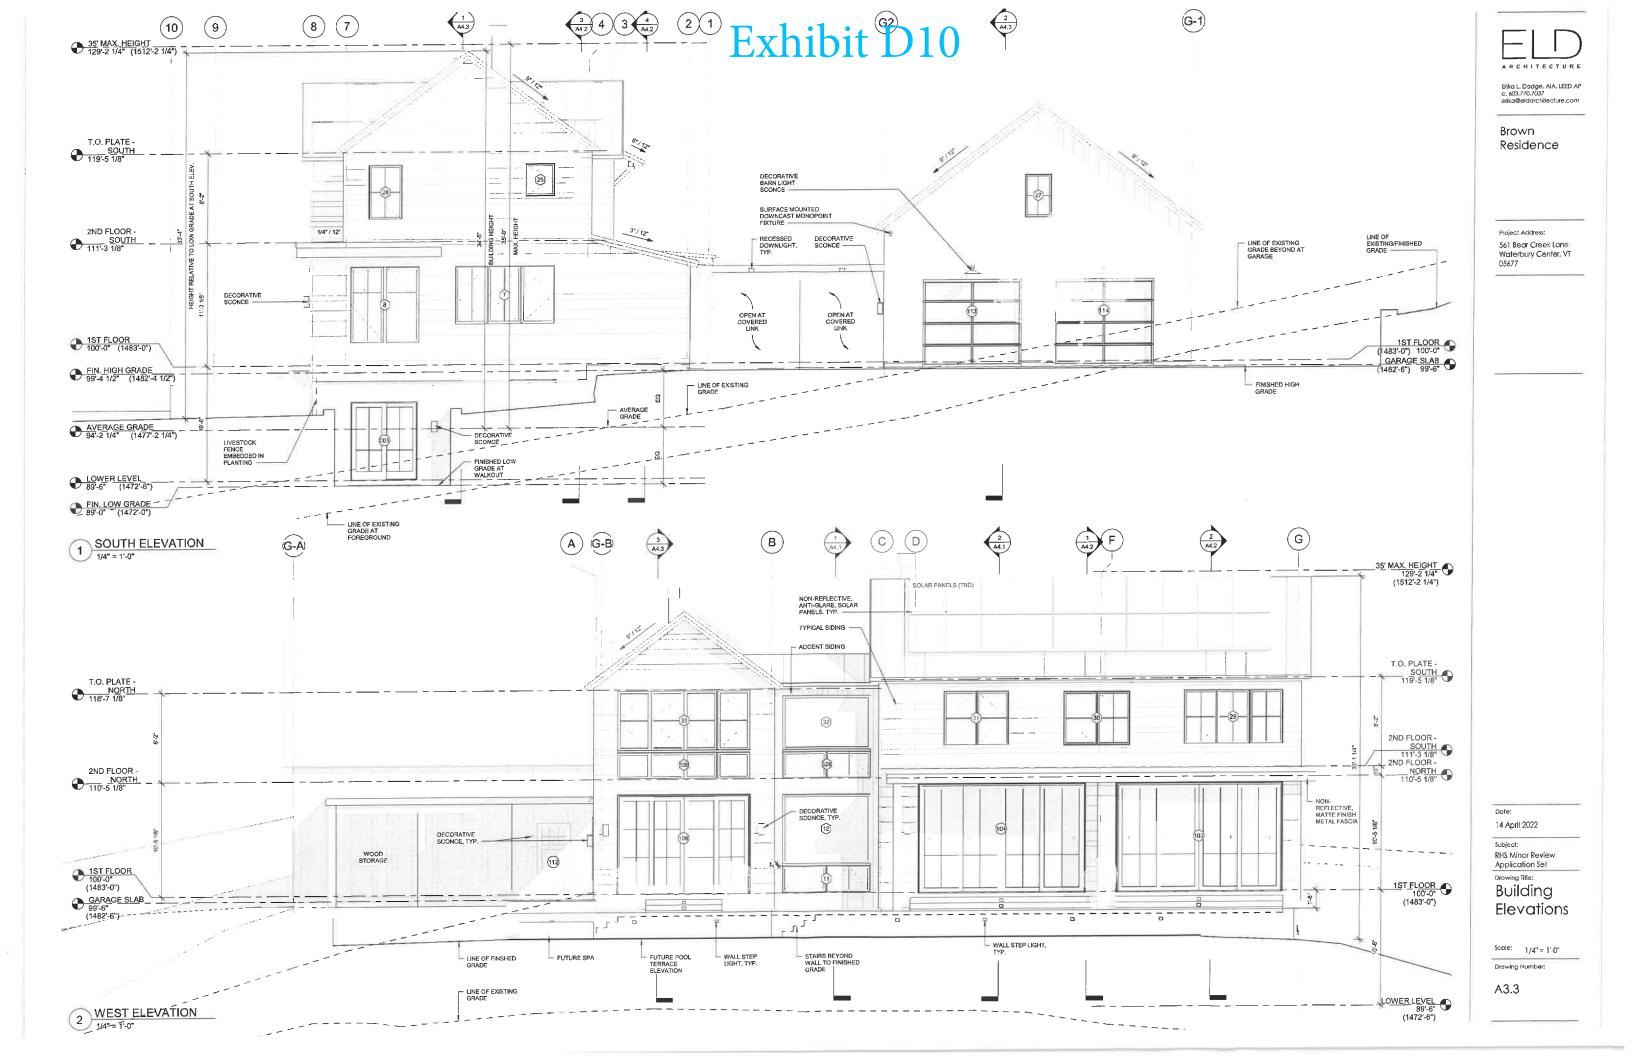

Marcan St. KITCHEN

0.0

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FUTURE PLANTING BED

DECORATIVE SCONCE BELOW AT BASEMENT SLIDER

LINE OF ROOF ABOVE, TYP.

RECESSED DOWNLIGHT, TYP.

WALL STEP LIGHT, TYP.

200 D. 20 200

IVING

WALL STEP LIGHT, TYP.





FIRST FLOOR LIGHTING PLAN (1)1/8" = 1'-0"

FUTURE PLANTING BED

É.

GARAGE

x ---- x ----- x

0

63-

0 COVERED

FIREPIT

-DECORATIVE

BBQ

FUTURE

DECORATIVE BARN LIGHT SCONCE ABOVE OVERHEAD DOOR, TYP.

MONOPOINT FIXTURE AT AUTOCOURT DECORATIVE SCONCE, TYP

RECESSED DOWNLIGHT, TYP

MUDROOM

12 4-----

0

JUSTIN'S OFFICE

PHASE 2 FUTURE POOL TERRACE

-¥

- **T** - **T** --1-1-1 COVERED ENTRY

FORMAL

MAIN TERRACE

FUTURE POOL

L

DECORATIVE WALL SCONCE OPTIONS



TYPICAL SCONCE CIRCA LIGHTING CYLINDER



SCONCE AT COVERED ENTRY CHARA 26 OUTDOOR WALL BY TECH LIGHTING

DECORATIVE BARN LIGHT SCONCE OPTIONS



OPTION 1 REJUVENATION CARSON L-ARM





BK LIGHTING NIGHTSTAR

RECESSED DOWNLIGHTS



BK LIGHTING VERSA STAR



OPTION 2 STEEL LIGHTING CO. GARDENA

WALL STEP LIGHTS



WAC LIGHTING WALL STEP

				Γ	_	-)
ARCHI	T	E	¢	T	Ų	R	E

Erika L. Dodge, AIA, LEED AP c. 603.770.7037 erika@eldarchitecture.com

Brown Residence

Project Address: 561 Bear Creek Lane Waterbury Center, VT 05677

Date:

14 April 2022

Subject: RHS Minor Review Application Set Drawing Title:

Exterior Lighting Plan

Scale: 1/8" = 1'-0"

Drawing Number:

E1.0

CHARA 26 OUTDOOR WALL

Strikingly elegant in its simplicity, the Chara 26 Wall Sconce is a tubular design that creates a modern industrial look. Designed with a die-cast aluminum structure, powder coat finish, and stainless steel hardware for robust durability in harsh elements. Appropriate for commercial use. Available as Square or Round in three sizes.

FORMAL ENTRY SCONCES

TECH LIGHTING

Outstanding protection against the elements:

- Powder coat finish
- Stainless Steel mounting hardware
- IP65 rated

SPECIFICATIONS

LUMENS	1286
WATTS	11.8
VOLTAGE	Universal 120-277V, with integral transient 2.5kV surge protection (driver)
DIMMING	0-10, ELV, Triac
LIGHT DISTRIBUTION	Symmetric
OPTICS	Not applicable
MOUNTING OPTIONS	Wall
ADJUSTABILITY	None
ССТ	3000K
CRI	90+
COLOR BINNING	3 Step
BUG RATING	B1-U4-G0
DARK SKY	Non-Compliant
WET LISTED	IP65
GENERAL LISTING	ETL
CALIFORNIA TITLE 24	Can be used to comply with CEC 2019 Title 24 Part 6 for outdoor use. Registration with CEC Appliance Database not required.
START TEMP	-30°C
FIELD SERVICEABLE LED	Yes
CONSTRUCTION	Aluminum
HARDWARE	Stainless Steel
FINISH	Powder Coat
LED LIFETIME	L70: >60,000 Hours
WARRANTY*	5 Years
WEIGHT	4 lbs.



CHARA 26 OUTDOOR WALL shown in black


* Visit techlighting.com for specific warranty limitations and details.

ORDERING INFORMATION

PRODUCT	CRI/CCT	LENGTH	FINISH	FUNCTION	VOLTAGE	DISTRIBUTION
7000WCHA	930 90 CRI, 3000K	26 26°	B BLACK	UD UPLIGHT/DOWNLIGHT	UNV 120V-277V	5 SYMMETRIC

CHARA 26 OUTDOOR WALL

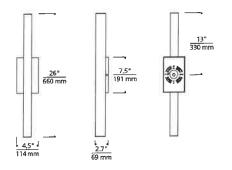
TECH LIGHTING



Chara 26 Outdoor Wall

PHOTOMETRICS*

CHARA 26 OUTDOOR	WALL-0
Total Lumen Output:	1286
Total Power:	11.8
Luminaire Efficacy:	109
Color Temp:	3000K
CRI:	90+
BUG Rating:	B1-U4-G0

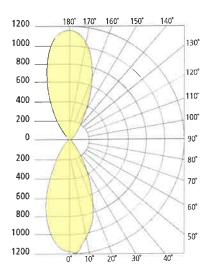

PROJECT INFO

FIXTURE TYPE EQUARIENT

JOB TAME & INFO

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TECH LIGHTING

VISUAI, COMFORT & CO. 7400 Linder Avenue, Skokie, Illinois 60077 T 847.410.4400

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*For fatest photometrics, please visit www.techt.phting.com/OUTDOOR
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TYPICAL DECORATIVE SCONCE THROUGHOUT

13590BK-LL

SILO

SMALL DOWN LIGHT WALL MOUNT LANTERN

The perfect addition to modern coastal, Silo's compact design blends simple modern and longlasting practicality. Part of the Coastal Elements collection, it is built to stand up to harsh climates while maintaining its bold finish. Silo is available in a downlight only option which meets dark sky compliancy, an up and downlight for additional wall washing, and a small flush mount. Silo is available in three modern finishes: Black, Architectural Bronze and Satin White, which are resistant to rust and corrosion with a 5-year warranty.

DETAILS		
FINISH:	Black	
MATERIAL:	Composite	
GLASS:	Etched	

DIMENSIONS	
WIDTH:	4.5"
HEIGHT:	8"
WEIGHT:	1.3lb
BACK PLATE:	4.5"W x 4.75"H
EXTENSION:	5.8"
TOP TO OUTLET:	4"

LIGHT SOURCE

LIGHT SOURCE				
LIGHT SOURCE:	LED Lamp			
LED NAME:	GU10LED-3K			
WATTAGE:	1-6w GU10 LED *Included			
VOLTAGE:	120v			
COLOR TEMP:	3000			
LUMENS:	500			
CRI:	80			
INCANDESCENT EQUIVALENCY:	1 x 50w			
DIMMABLE:	Yes - CL Type Dimmer (SSL7A)			

SHIPPING		
CARTON LENGTH:	8.3	
CARTON WIDTH:	10.2	
CARTON HEIGHT:	6.7	
CARTON WEIGHT:	2.4	







PRODUCT DETAILS:

- · Mounting hardware is hidden on the backplate to ensure a clean silhouette
- Suitable for use In wet (outdoor direct rain or sprinkler) locations as defined by NEC and CEC. Meets United States UL Underwriters Laboratories & CSA Canadian Standards Association Product Safety Standards
- · Fixture is Dark Sky compliant and engineered to minimize light glare upward into the night sky
- · Meets California Energy Commission Title regulations/JA8 when using the included LED bulb
- LED Lamps carry a 3-year limited warranty
- 5 year finish warranty
- The Coastal Elements Collection offers versatile designs, constructed of composite materials and coated with anti-fading finishes, for maximum durability in harsh climates.
- Bold lines and a clean, minimalist style complement contemporary architecture

HINKLEY

HINKLEY 33000 Pin Oak Parkway Avon Lake, OH 44012 PHONE: (440) 653-5500 Toll Free: 1 (800) 446-5539 hinkley.com

Model: WL-LED100

LEDme® Step Light

STEP LIGHT AT LANDSCAPE WALLS AND STEPS AT MAIN TERRACE



WAC LIGHTING

Responsible Lighting®

Fixture Type:	
Catalog Numbe	r:

3"

Project:

Exhibit E5

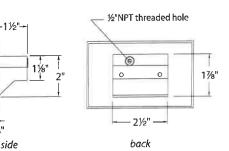
Location:

0

5'

2%"

front



SPECIFICATIONS

1 1/8"

Construction:	Die-cast aluminum or 316 marine grade cast stainless steel
Power:	Direct wiring, no remote driver needed. Input voltage: 120V or 277VAC 50/60Hz
Light Source:	2700K or 3000K CCT Samsung HV-AC High Power LED, CRI: 90 Optional color lenses. Total power consumption of 3.5W
Mounting:	Fits into $2^{"} \times 4^{"}$ J-Box with minimum inside dimensions of $3^{"}L \times 2^{"}W \times 2^{"}H$ Includes bracket for J-Box mount.
Dimming:	Dim to 10% with electronic low voltage (ELV) dimmer Approved dimmers: Lutron Nova-T NTELV-300 & NTELV-600, Lutron Vietri VTELV-600, Lutron Diva DVELV-300P, Lutron Skylark SELV-300P, Lutron Maestro MAELV-600
Standards:	IP66, UL & cUL Listed for wet locations, Title 24 JA8-2016 Compliant.

- | |--


3/16"

side

OPDER NUMBER

120V Model #		Light	Color		Fir	nish	277V Model #		Ligh	t Color		Fi	nish
WL-LED100	20V	27 C AM RD BL	Warm W <mark>hite</mark> Amber Red Blue	2700K 3000K 610nm 640nm 450nm	22	Black on Aluminum Brushed Nickel on Aluminum Bronze on Aluminum Graphite on Aluminum Stainless Steel White on Aluminum	WL-LED100F	2771'	C AM RD BL	White Amber Red Blue	3000K 610nm 640nm 450nm	BK BN* BZ GH SS WT	Black on Alaminum Brasned Nickel on Alaminum Bronze on Aluminum Graphite on Aluminum Stainless Steel White on Aluminum
WL-LED100	2017	27 C AM	White Amber	2700K 3000K 610nm	BBR	Bronze on brass							

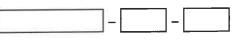*Brushed Nickel Finish is for interior use only



Example: WL-LED100F-BL-SS

waclighting.com Phone (800) 526.2588 (800) 526.2585 Fax

Headquarters/Eastern Distribution Center 44 Harbor Park Drive Port Washington, NY 11050

Central Distribution Center 1600 Distribution Ct Lithia Springs, GA 30122

Western Distribution Center 1750 Archibald Avenue Ontario, CA 91760

WAC Lighting retains the right to modify the design of our products at any time as part of the company's continuous improvement program. DEC 2021



Horizontal rectangle LEDme* Step Light. Designed for safety and style on stairways, patios, decks, balcony areas, walkways and building perimeters.

Features an architectural design. Energy efficient for long-lasting indoor and outdoor lighting solutions. Creates an attractive, romantic impression at night.


FEATURES

- Solid diecast brass, corrosion resistant aluminum alloy, or cast stainless steel construction
- · Direct wiring, no driver needed
- Low profile, flush to wall aesthetics with no visible hardware
- 54,000 hour rated life
- Balanced lighting, free of shadows with minimum glare
- IP66 rated, Protected against high-pressure water jets
- Up to 200 fixtures can be connected in parallel
- 5 year WAC Lighting product warranty

NITE ST	AR (MR16)		IP66 RATED
⊃ <u>≉</u> ∓7	FROJECT	TYPE:	
t, AtAccohitM	in H i ik		



CATALOG NUMBER LOGIC	
NS - 502 - BLP	
SERIES	
NS - Nite Star	
LAMP TYPE	
0 - By Others	
500 - 7W/15DEG/2700K	
501 - 7.5W/25DEG/2700K	
502 - 7.5W/35DEG/2700K	
503 - 7W/15DEG/3000K	
504 - 7.5W/25DEG/3000K	
505 - 7.5W/35DEG/3000K	
FINISH (See below for full-color swatches)	
Standard Finishes (BZP, BZW, BLP, BLW, WHP, WHW, SA	P, VER)

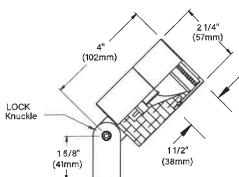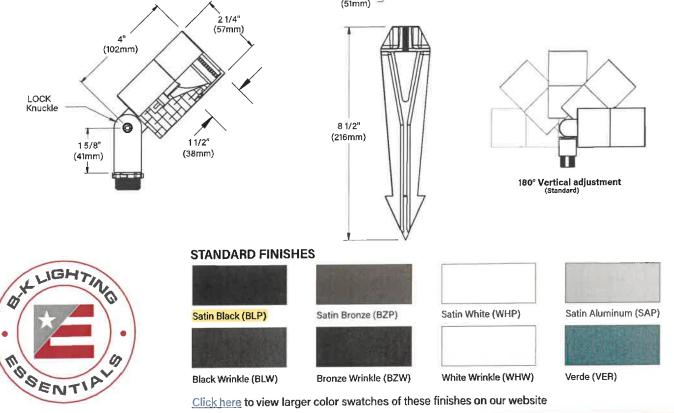


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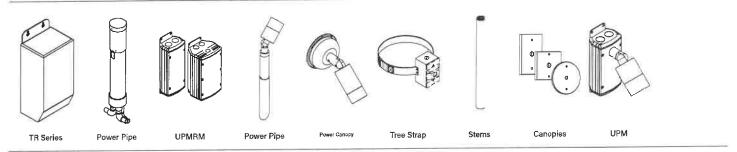
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05/12/2021 SKU-320

NITE STAR (MR16)			IP66 RATED
DATE:	FROJECT	TYPE;	
D,47E;	FROJECT	ि\ि; ;	

ACCESSOT @S (Configure reparately)



SPECIFICATIONS

ELECTRICAL	WATTAGE WIRING TRANSFORMER	7W or 7.5W Teflon® coated wire, 18AWG, 600V, 250° C rated and certified to UL 1659 standard. For use with 12 VAC remote transformer.
PHYSICAL	MATERIALS	Furnished in copper-free aluminum (6061-T6).
	BODY	Unibody design is fully machined from solid billet and provides enclosed, water-proof wireway and heat sink to maximize lamp life. High temperature, silicone 'O' Ring provides watertight seal.
	KNUCKLE	LOCK Knuckle is comprised of two components. The first is integral to the body and features an interior, machined taper. The second is machined from solid billet and features a second, reverse angle taper. The resultant mechanical taper-lock allows a full 180° vertical adjustment without the use of serrated teeth, which inherently limit aiming. High temperature, silicone 'O' Ring provides water-tight seal and compressive resistance to maintain fixture position. Design withstands 73 lb. static load prior to movement to ensure decades of optical alignment. V2" pipe thread for mounting.
	CAP	Fully machined with a flush mounted lens.
	LENS	Shock resistant, tempered, clear glass lens is factory adhered to fixture cap and provides hermetically sealed optical compartment.
	SOCKET	Specification grade, ceramic body lamp holder. GU5.3 base. Nickel allow contacts and heat resistant, spring loaded, stainless steel lamp retaining clips.
	LAMP TYPE	MR16 Green Creative LED Lamp, Title 20 and Title 24, JA8 compliant. Compatible with 50 watt maximum, MR16 lamp.* Not for use with IR technology lamps. Halogen sourced by others. *Except GE Light Q42MR16/C/VNSP9 (EZY).
	HARDWARE	Tamper-resistant, stainless steel hardware. LOCK aiming screw is black oxide treated for additional corrosion resistance.
	FINISH	StarGuard, our 15-stage chromate-free process cleans and conversion coats aluminum components prior to application of Class 'A' TGIC polyester powder coating and is RoHS compliant.
	WARRANTY	5-year limited warranty.
	CERTIFICATION & LISTING	UL Listed. Certified to CAN/CSA/ANSI Standards. RoHS compliant. Title 24 and JA8 compliant (when using factory lamp options). Suitable for indoor or outdoor use, in wet locations, and within 4′ of the ground. Made in the USA with sustainable processes.
	INCLUDED ITEMS	Fixture, mounting stake, and Honeycomb Baffle accessory.



B-K LIGHTING





MADE IN THE USA


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VERSA STAR LED (CORE DRILL)		
-TAC	PROJECT	TYPE:

PROJECT.

CATALOG NUMBER LOGIC



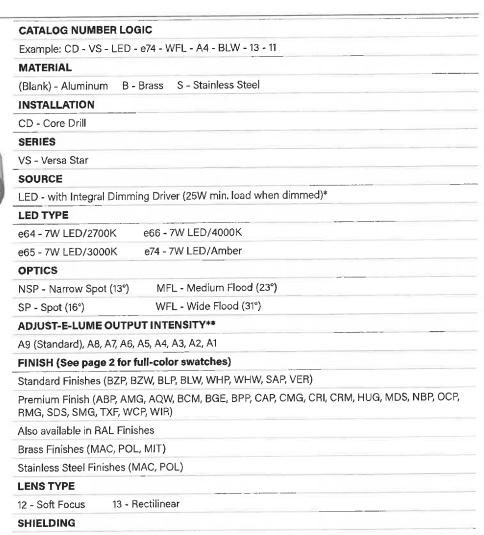11 - Honeycomb Baffle

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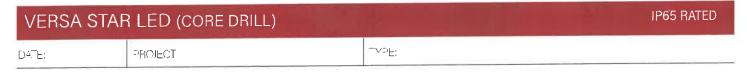
01/31/2020 SKU-586 SUB000937




*Requires magnetic low voltage dimmer.

determine desired intensity.

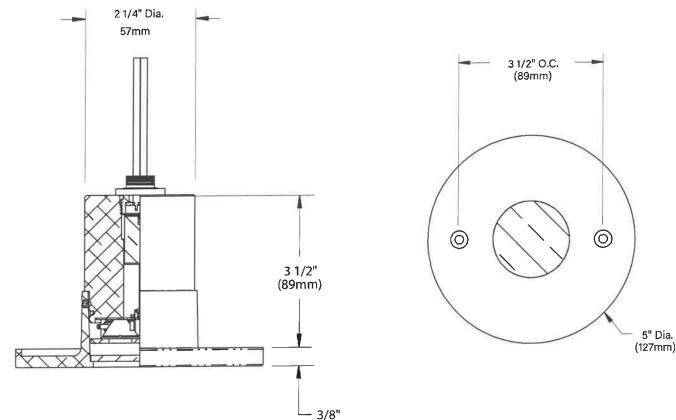**Please see Adjust-e-Lume photometry to





(10mm)

STANDARD FINISHES



<u>Click Here</u> to view larger, full-color swatches of all available finishes on our website.

PREMIUM FINISHES



B-K LIGHTING MADE IN THE USA 559.438.58


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01/31/2020 SKU-586 SUB000937

VERSA ST	AR LED (CORE DRILL)		IP65 RATED
DATE:	PROJECT	~~:E:	

Accessor es (Configure separately)



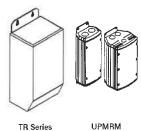TR Series

SPECIFICATIONS

ELECTRICAL	WATTAGE	7W LED
	ADJUST-E-LUME	Integral electronics allow for dynamic lumen response at the individual fixture. Indexed (100% to 25% nom.) Iumen output. Maintains output at desired level or may be changed. Specify factory preset output intensity.
	WIRING	Teflon [®] coated, 18AWG, 600V, 250° C rated and certified to UL 1659 standard. Anti-Siphon Valve (ASV) prevents wicking through conductor insulation.
	REMOTE TRANSFORMER	For use with 12VAC remote transformer or magnetic transformers only. B-K Lighting cannot guarantee performance with third party manufacturers' transformers.
PHYSICAL	MATERIALS	Furnished in copper-free aluminum (6061-T6), brass (360) or stainless steel (304).
	CORE DRILL	Allows for mounting into existing structures that will not easily accept a standard box. 2-1/2" dia. hole required for slip fit.
	BODY	Unibody design with enclosed, water-proof wireway and integral heat sink is fully machined from solid billet.
	FACEPLATE	Fully machined from solid billet. Countersunk holes provide for flush hardware mounting (by others). Accommodates (1) lens or louver media.
	LENS	Shock resistant, tempered, glass lens is factory adhered to faceplate and provides hermetically sealed optical compartment.
	LED	Integrated solid state system and modular design with electrical disconnects allow for easy field upgrade and maintenance. High power, forward throw source complies with ANSI C78.377 binning requirements and exceeds ENERGY STAR ^a lumen maintenance requirements. LM-80 certified components. Integral, constant current driver. 12VAC/VDC input. 50/60Hz. Proprietary input control scheme achieves power factor correction and eliminates inrush current (limited to <250mA non-dimming). Output, overvoltage, open- circuit, and short circuit protected. Conforms to Safety Std. C22.2 No. 250.13-12.
	DIMMING	Line voltage dimmable via magnetic low voltage dimmer with dedicated neutral conductor. Remote magnetic transformer with LED loads should be loaded to 25% of the transformer VA (watts) rated value.
	OPTICS	Interchangeable OPTIKIT modules permit optical field changes. Color-code: Narrow Spot (NSP) = red; Spot (SP) = green; Medium Flood (MFL) = yellow; Wide Flood (WFL) = blue.
	HARDWARE	Tamper-resistant, stainless steel hardware (by others). Faceplate screws are black oxide treated for additional corrosion resistance.
	FINISH	StarGuard, our 15-stage chromate-free process cleans and conversion coats aluminum components prior to application of Class 'A' TGIC polyester powder coating and is RoHS compliant, Powder coat or metal finish options available for brass material and metal finish option only for stainless steel material.
	WARRANTY	5-year limited warranty.
	CERTIFICATION & LISTING	ITL tested to IESNA LM-79. UL Listed. Certified to CAN/CSA/ANSI Standards. RoHS compliant. Suitable for indoor or outdoor use, in wet locations, and for installation within 4' of the ground. IP65 Rated. Made in the USA with sustainable processes.



B-K LIGHTING

MADE IN THE USA

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01/31/2020 SKU-586 SUB000937

LAMP & DRIVER DATA (e64, e65, e66, e74)

DAT-

FROJECT:

TYPE

CATALUG NUMBER LOGIC

DRIVER	Input Volts	InRush Current	Operating	Dimmable	Operation Ambient Temperature	
DATA	12VAC/DC 50/60Hz	<250mA (non-dimmed)	700mA	Magnetic Low Voltage Dimmer	-22°F-194°F (-30°C - 90°C)	

ССТ			L70 DATA	OPTICAL DATA			
(Typ.)	CRI (Typ.)	Input Watts (Typ.)	Minimum Rated Life (hrs.) 70% of initial lumens (L_{70})	Angle	CBCP	Delivered Lumens	Multiplier
2700K	80	7	50,000	13°	5993	456	0.87
2700K	80	7	50,000	16°	4546	445	0.87
2700K	80	7	50,000	23°	1726	397	0.87
2700K	80	7	50,000	31°	1131	399	0.87
3000K	80	7	50,000	13°	6131	466	0.89
3000K	80	7	50,000	16°	4650	455	0.89
3000K	80	7	50,000	23	1766	406	0.89
3000K	80	7	50,000	31°	1157	409	0.89
4000K	80	7	50,000	13°	6889	524	
4000K	80	7	50,000	16°	5225	511	
4000K	80	7	50,000	23°	1984	456	
4000K	80	7	50,000	31°	1300	459	
Amber	80	7	50,000	13°	3,927	299	0.57
Amber	80	7	50,000	16°	2,978	291	0.57
Amber	80	7	50,000	23°	1,131	260	0.57
Amber	80	7	50,000	31°	741	262	0.57
	2700K 2700K 2700K 2700K 3000K 3000K 3000K 4000K 4000K 4000K 4000K 4000K Amber Amber	2700K 80 2700K 80 2700K 80 2700K 80 3000K 80 3000K 80 3000K 80 3000K 80 3000K 80 4000K 80 4000K 80 4000K 80 4000K 80 Amber 80 Amber 80 Amber 80	2700K 80 7 3000K 80 7 3000K 80 7 3000K 80 7 3000K 80 7 4000K 80 7 Amber 80 7 Amber 80 7	CYPY CYPY CYPY CYPY 2700K 80 7 50,000 3000K 80 7 50,000 4000K 80 7 50,000 4000K 80 7 50,000 4000K 80 7 50,000 Amber 80 7 50,000 Amber 80 7 50,000	CYPY CYPY <th< td=""><td>CYPY CYPY CYPY CYPY Solution Solution<td>(1yp.) (1yp.) <th(1yp.)< th=""> <th(1yp.)< t<="" td=""></th(1yp.)<></th(1yp.)<></td></td></th<>	CYPY CYPY CYPY CYPY Solution Solution <td>(1yp.) (1yp.) <th(1yp.)< th=""> <th(1yp.)< t<="" td=""></th(1yp.)<></th(1yp.)<></td>	(1yp.) (1yp.) <th(1yp.)< th=""> <th(1yp.)< t<="" td=""></th(1yp.)<></th(1yp.)<>

OPTICS


Angle
13°
16°
23°
31°

B-K LIGHTING


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Exhibit G1

Town of Waterbury Development Review Board Decision #001-21 = February 17/March 3, 2021

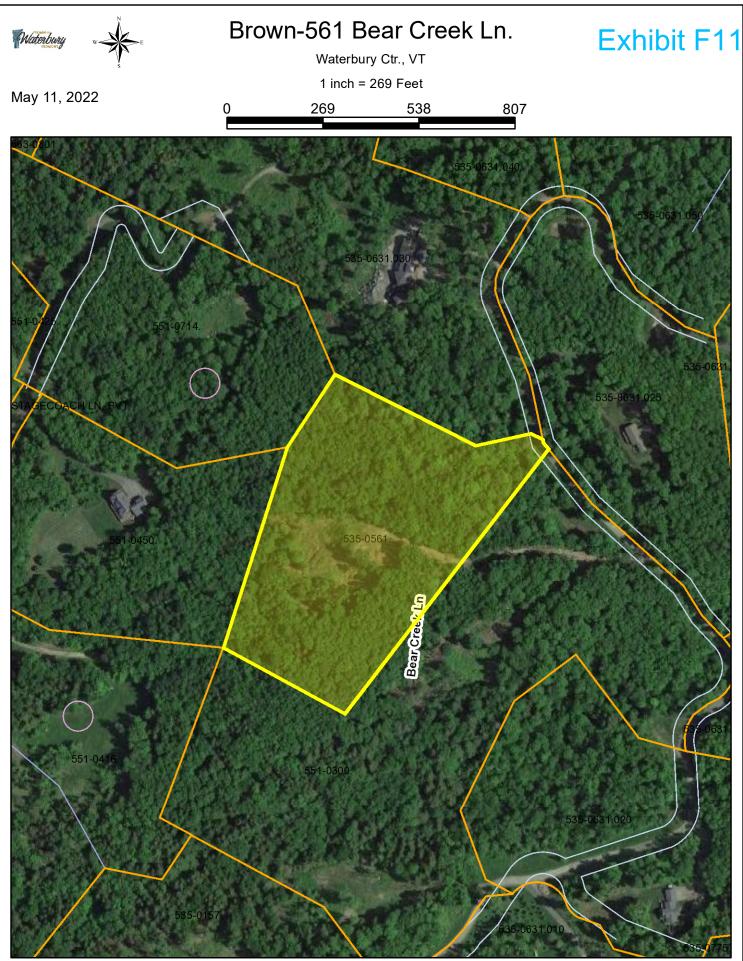Attending:

(2/17/21) Board members: Tom Kinley (Acting Chair), David Rogers (Vice Chair), Bud Wilson, Patrick Farrell, Harry Shepard, and George Lester. Staff: Dina Bookmyer-Baker (ZA), Steve Lotspeich (Community Planner), and Patti Martin (Secretary).

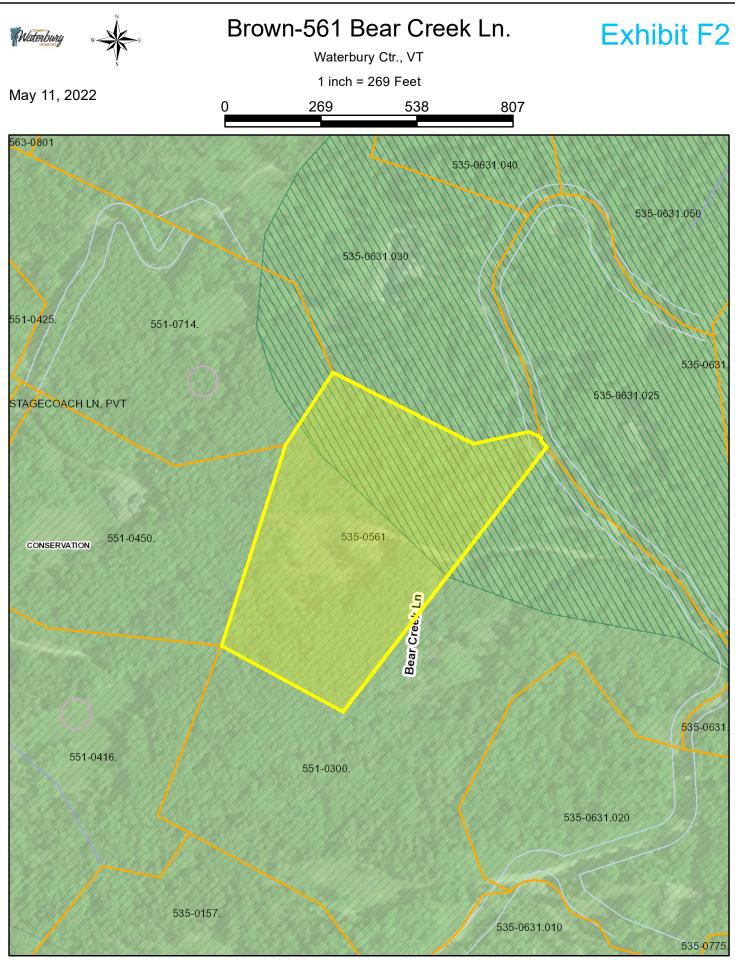(3/3/21) Board members: David Rogers (Acting Chair), Tom Kinley, Bud Wilson, Alex Tolstoi, Patrick Farrell, and Harry Shepard. Staff: Dina Bookmyer-Baker (ZA) and Patti Martin (Secretary).

Owner/Applicant:	Justin & Nusi Brown	
Address/Location:	561 Bear Creek Lane, Waterbury Center, VT	
Zones:	Conservation (CNS) and Ridgelines/Hillsides/Steep Slopes (RHS) overlay	
Application #	001-21 Tax Map # 14-065.	120

Applicant Request

The applicant seeks approval to revise the building zone and renew the previously-approved thinning envelope at 561 Bear Creek Lane in the Conservation (CNS) zoning district and Ridgelines, Hillsides, Steep Slopes (RHS) overlay district.

Present and sworn in:

(2/17/21) George McCain, McCain Consulting Inc., project consultant

(3/3/21) George McCain, McCain Consulting Inc., project consultant

Exhibits

- A: Application #001-21 (6 pp: Zoning, Conditional Use, Overlay District), submitted 1/18/21.
- B: Project overview, prepared by McCain Consulting, Inc., dated 1/18/21.
- C: Site Plan for Justin & Nusi Brown, Building Envelope Revisions—RHS Minor, prepared by McCain Consulting, Inc., Sheet C-1, dated 1/15/21; revised 2/23/21: *Thinning envelope revision per DRB comments*.
- D: Letter to adjoining landowners, mailed certified on 1/29/2021.
- E: (E1) Orthophoto with approximate parcel boundary; (E2) with zoning districts & contours. (Staff).
- F: Prior DRB decision #125-18 for a 4-lot subdivision creating Lots 12, 13, 14, & 15, associated Plan Sheets C-1, C-2, & C-4 (DRB 1/16/19); and final plat dated 4/26/19. (Staff)
- G: Prior DRB decision #67-16T for pre-development activity on Lots 12 & 13 (DRB 11/16/16), with associated Plan and View Sections. (Staff)

3/3/21

Exhibit G2

Conclusion:

Based upon these findings, and subject to the conditions set forth below, the Board concludes that the proposal by Justin & Nusi Brown to revise the building zone and renew the previously-approved thinning envelope at 561 Bear Creek Lane, as presented in application #001-21 and supporting materials, meets the Conditional Use and Ridgeline/Hillside/Steep Slope and criteria as set forth in Sections 303 and 1004.

Motion:

On behalf of the Waterbury Development Review Board, Tom Kinley moved and Harry Shepard seconded the motion to approve application #001-21 with the following conditions:

- (1) The Applicant shall complete the project in accordance with the Board's findings and conclusions and the approved plans and exhibits;
- (2) Future development is subject to review by the Board for compliance with the RHS criteria.
- (3) Except as amended herein, this approval incorporates all Findings of Fact, Conclusions of Law, and Conditions in zoning permits #67-16T, #125-18, and #027-20.

Vote: The motion was approved 6–0.

David Rogers (David Rogers, Acting Chair)

Approved: March 3, 2021

State permits may be required for this project. The landowner/applicant is advised to contact Peter Kopsco, DEC Permit Specialist, at 802-505-5367 or pete.kopsco@vermont.gov, and the appropriate state agencies to determine what permits must be obtained.

NOTICE: This decision may be appealed to the Environmental Division of the Vermont Superior Court by an interested person who participated in the proceeding(s) before the Development Review Board. An appeal must be taken within 30 days of the date of this decision, pursuant to 24 V.S.A. § 4471 and Rule 5(b) of the Vermont Rules for Environmental Court Proceedings.

3/3/21

